SITE PLAN & DESIGN REVIEW 28TH AUG, 2024

SINGLE FAMILY RESIDENCE + JADU + ADU

477 TROWBRIDGE LN, FOLSOM, CA 95630



ABBREVIATIONS

ABBR	TERM
&	AND
@	AT
±	PLUS / MINUS
Ø	DIAMETER
0	DEGREE
1SRS	ONE-PART SILICONE RUBBER SEALANT
2PUMS	TWO-PART POLYURETHANE MODIFIED SEALANT
2PUS	TWO-PART POLYURETHANE SEALANT
2003	TWO-FART FOLTORETHANE SEALANT
A.W.I	ARCHITECTURAL WOODWORKING INSTITUTE
ABV	ABOVE
ACOUS	ACOUSTICAL
ACT	ACOUSTICAL CEILING TILE
AD	AREA DRAIN
ADA	AMERICANS WITH DISABILITIES ACT
ADJ	ADJUSTIBLE
ADJ	ADJACENT
AFF	ABOVE FINISHED FLOOR
ALS	ACRYLIC LATEX SEALANT
ALUM	ALUMINUM
ANOD	ANODIZED
AP	ACCESS PANEL
ARCH	ARCHITECT
ASSEM	ASSEMBLY
AST	ASPHALT COMPOSITION TILES
AVG	AVERAGE
В	BALCONY
BC	BRICK COURSE
BD	BALCONY DRAIN
BITUM	BITUMINOUS
BKT	BRACKET
BLDG	BUILDING
BLT-IN	BUILT-IN
BM	BEAM
ВОН	BACK OF HOUSE
BR	BRICK
BUR	BUILT-UP ROOF
BZ	BRONZE
CA	CONSTRUCTION ADMINISTRATOR
CAB	CABINET
CB	CATCH BASIN
CC	CEMENTITIOUS COATING
CCT	COVE CERAMIC TILE
CEM	CEMENT
CJ	CONTROL JOINT
CJF	CORK JOINT FILLER
CL	CENTERLINE
CLG	CEILING
CLO	CLOSET
CLR	CLEAR
CMU	CONCRETE MASONRY UNIT
COL	COLUMN
CONC	CONCRETE
CONF	CONFERENCE
CONN	CONNECTION
CONST	CONSTRUCTION
CONT	CONTINUOUS
CORR	CORRIDOR
CPT	CARPET
CS	CONCEALED SPLINE
CT	CERAMIC TILE
CTR	CENTER
CW	COLD WATER
D	DEPTH
DEMO	DEMOLITION
DIA	DIAMETER
DIM	DIMENSION
DISP	DISPENSER
DISPL	DISPOSAL
DN	DOWN
DP	DAMPPROOFING
DR	DOOR
DC	DOWNSPOUT
טס	
DS DTL	DETAIL
	DETAIL DRYWALL DRAWING


ELECTRICAL CONTRACTOR
EXTERIOR INSULATION AND FINISH SYSTEM


ABBR	TERM	ABBR	TERM
EJ	EXPANSION JOINT	KE	KITCHEN EXHAUST
EL	ELEVATION	KIT	KITCHEN
ELEC ELEV	ELECTRICAL ELEVATOR	KL	KNURLED LEVER (PUBLIC SIDE)
EM	ENTRANCE MAT	L	LENGTH
ENCL	ENCLOSURE	LAM	LAMINATE
ENG	ENGINEER EVENANDED DOLVETUVI ENE JOINT EILLED	LAV	LAVATORY
EPEJF EQ	EXPANDED POLYETHYLENE JOINT FILLER EQUAL	LBS LEFEV	POUNDS LOW-EMITTING FUEL EFFICIENT VEHICLE
EQUIP	EQUIPMENT	LIN	LINEAR
EST	ESTIMATE	LT	LIGHT / LIGHTING
EVCS	ELECTRIC VEHICLE ELECTRIC VEHICLE CHARGING STATION	MACH	MACHINE
EWC	ELECTRICAL WATER CLOSET	MAR	MARBLE
EX	EXISTING	MAS	MASONRY
EXH	EXHAUST	MAX	MAXIMUM
EXP EXSB	EXPANSION EXTERIOR GRADE SOFFIT BOARD	MD MDF	MECHANICAL CONTRACTOR MEDIUM DENSITY FIBER BOARD
EXTR	EXTERIOR	MDO	MEDIUM DENSITY OVERLAY
	-	MECH	MECHANICAL
F&I	FURNISH AND INSTALL	MEMB	MEMBRANE
FAB FD	FABRICATE FLOOR DRAIN	MFD MFR	MANUFACTURED MANUFACTURER
FE FE	FIRE EXTINGUISHER	MH	MANHOLE
FEC	FIRE EXTINGUISHER CABINET	MIL	MILLIMETER
FIN	FINISH(ED)	MIN	MINIMUM
FLG FLR	FLOORING FLOOR	MIRR MISC	MIRROR MISCELLANEOUS
FLUOR	FLUORESCENT	MO	MASONRY OPENING
FND	FOUNDATION	MRNG	MOLDED RESILIENT NEOPRENE GASKET
FO	FACE OF	MTL	METAL
FP FR	FIREPROOF(ING) FIRE RATED	MULL MW	MULLION MICROWAVE
FRT	FIRE RETARDANT TREATED (WOOD	MW	METALLIC WATERPROOFING
	CONSTRUCTION)		
FT FTG	FOOT / FEET FOOTING	NAP	NAPKIN
110	rooma	NIC NO	NOT IN CONTRACT NUMBER
G	GRANITE	NOM	NOMINAL
GA	GAUGE	NTS	NOT TO SCALE
GALV GC	GALVANIZED GENERAL CONTRACTOR	OA	OUTCIDE AID
GD	GARAGE DRAIN	OC	OUTSIDE AIR ON CENTER
GDIS	GARBAGE DISPOSAL	OD	OUTSIDE DIAMETER
GL	GLASS / GLAZING / GLAZE	OFF	OFFICE
GR GUT	GRADE GUTTER	OPG OPP	OPENING OPPOSITE
GWB	GYPSUM WALL BOARD	OZ	OUNCE
GYP	GYPSUM		
Н	HIGH	P PD	PAINT
H/C	HANDICAPPED	PDR	PLANTER DRAIN POWDER
НВ	HOSE BIBB	PH	PENTHOUSE
HC	HOLLOW CORE	PL	PROPERTY LINE
HDF	HEAD HIGH DENSITY FIBER BOARD	PLAM PLAS	PLASTIC LAMINATE PLASTIC
HDWR	HARDWARE	PLBG	PLUMBING
НМ	HOLLOW METAL	PLT	PLATE
HNCG HOLD	HOLLOW NEOPRENE COMPRESSION GASKET HOLD DIMENSION	PLYWD	PLYWOOD
HORZ	HORIZONTAL	POL PP	POLISHED PRECAST PAVERS
HP	HOLD POINT	PPMC	POLYISOBUTYLENE / POLYBUTENE MASTIC
HR	HOUR		COMPOUND
HT HTH	HEIGHT HARD TROWEL, MOIST CURE AND HARDENER	PSF PT	POUNDS PER SQUARE FOOT PRESSURE TREATED
HTS	HARD TROWEL, MOIST CURE AND SEALER	PTD	PAINTED PAINTED
HVAC	HEATING, VENTILATING, AND AIR	PTN	PARTITION
1.1\A/	CONDITIONING	PVC	POLY VINYL CHLORIDE
HWH	HOT WATER HOT WATER HEATER	QTY	QUANTITY
		WII	QONITH I
ICE	ICE MAKER	R	RISER
ID IN	INSIDE DIAMETER INCH	R.	RADIUS
INCAND	INCANDESCENT	RB RD	RESILIENT BASE ROOF DRAIN
INSUL	INSULATION	RECT	RECTANGULAR
INT	INTERIOR	REF	REFERENCE
J-BOX	ILINCTION POY	REFRIG	REFRIGERATOR
J-BOX	JUNCTION BOX JANITOR	REINF REQ'D	REINFORCING REQUIRED
	JANITOR'S CLOSET	REV	REVISION
JC			RESILIENT FLOORING
JST	JOIST	RF	
	JOINT	RF	ROOF
JST			

ABBR	TERM
RO	ROUGH OPENING
RRD	RADIUS ROOF DRAIN
RT	RESILIENT TILE
CAN	CANITADY
SAN SC	SANITARY SOLID CORE
SCH	SCHEDULE
SEC	SECTION
SECY	SECRETARY
SF SFO	SQUARE FOOT
SFO	SOLICITATION FOR OFFER
SHT	SHEET
SIM	SIMILAR
SP	STAIR PRESSURIZATION
SPE	STAND PIPE EXTENSION
SPEC	SPECIFICATION
SQ	SQUARE
SQ YD	SQUARE YARD
SS	STAINLESS STEEL
SSS	SILICONE SANITARY SEALANT
ST	STONE
STD	STANDARD
STL	STEEL
STP	STAND PIPE
STR	STAIR
STRUC	STRUCTURE / STRUCTURAL
SUP	SUPPLY
SUSP	SUSPENDED
SYM	SYMETRICAL
SYS	SYSTEM
Т	TREAD
T&G	TONGUE & GROOVE
T/	TOP OF
TBD	TO BE DETERMINED
TBS	TO BE SPECIFIED
TE	TOILET EXHAUST
TEL	TELEPHONE
TEMP	TEMPERATURE
TGL	TEMPERED GLASS
THD	THRESHOLD
THK	THICK
TLT	TOILET
TOP	TOP OF PARAPET
TOS	TOP OF SLAB
TYP	TYPICAL
UL	UNDERWRITER'S LABORATORY
UNO	UNLESS NOTED OTHERWISE
USG	U.S. GYPSUM COMPANY
V	VINYL FABRIC
VCT	VINYL COMPOSITION TILE
	VERTICAL
VERT	
	VESTIBULE
VEST	VESTIBULE VERIFY IN FIELD
VERT VEST VIF VWC	
VEST VIF	VERIFY IN FIELD
VEST VIF	VERIFY IN FIELD
VEST VIF VWC	VERIFY IN FIELD VINYL WALL COVERING
VEST VIF VWC	VERIFY IN FIELD VINYL WALL COVERING WIDE / WIDTH
VEST VIF VWC W	VERIFY IN FIELD VINYL WALL COVERING WIDE / WIDTH WITH
VEST VIF VWC W W/ W/O	VERIFY IN FIELD VINYL WALL COVERING WIDE / WIDTH WITH WITHOUT
VEST VIF VWC W W/ W/O WC WD	VERIFY IN FIELD VINYL WALL COVERING WIDE / WIDTH WITH WITHOUT WATER CLOSET WOOD
VEST VIF VWC W W/O WC WD WDG	VERIFY IN FIELD VINYL WALL COVERING WIDE / WIDTH WITH WITHOUT WATER CLOSET WOOD WDG ARCHITECTURE
VEST VIF VWC W W/O WC WD WDG WP	VERIFY IN FIELD VINYL WALL COVERING WIDE / WIDTH WITH WITHOUT WATER CLOSET WOOD WDG ARCHITECTURE WATERPROOFING
VEST VIF VWC W W/ W/O WC WD WDG WP WPMEM	VERIFY IN FIELD VINYL WALL COVERING WIDE / WIDTH WITH WITHOUT WATER CLOSET WOOD WDG ARCHITECTURE WATERPROOFING WATERPROOF MEMBRANE
VEST VIF VWC W W/O WC WD WDG WP WPMEM WPT	VERIFY IN FIELD VINYL WALL COVERING WIDE / WIDTH WITH WITHOUT WATER CLOSET WOOD WDG ARCHITECTURE WATERPROOFING WATERPROOF MEMBRANE WORKING POINT
VEST VIF VWC W W/O WC WD WDG WP WPMEM WPT WRB	VERIFY IN FIELD VINYL WALL COVERING WIDE / WIDTH WITH WITHOUT WATER CLOSET WOOD WDG ARCHITECTURE WATERPROOFING WATERPROOF MEMBRANE WORKING POINT WATER RESISTIVE BARRIER
VEST VIF VWC W W/O WC WD WDG WP WPMEM WPT WRB WRGB	VERIFY IN FIELD VINYL WALL COVERING WIDE / WIDTH WITH WITHOUT WATER CLOSET WOOD WDG ARCHITECTURE WATERPROOFING WATERPROOF MEMBRANE WORKING POINT WATER RESISTIVE BARRIER WATER RESISTANT GYPSUM BOARD
VEST VIF VWC W W/ W/O WC WD WDG WP WPMEM WPT WRB WRGB	VERIFY IN FIELD VINYL WALL COVERING WIDE / WIDTH WITH WITHOUT WATER CLOSET WOOD WDG ARCHITECTURE WATERPROOFING WATERPROOF MEMBRANE WORKING POINT WATER RESISTIVE BARRIER WATER RESISTANT GYPSUM BOARD WET STACK
VEST VIF VWC W W/O WC WD WDG WP WPMEM WPT WRB WRGB	VERIFY IN FIELD VINYL WALL COVERING WIDE / WIDTH WITH WITHOUT WATER CLOSET WOOD WDG ARCHITECTURE WATERPROOFING WATERPROOF MEMBRANE WORKING POINT WATER RESISTIVE BARRIER WATER RESISTANT GYPSUM BOARD
WEST VIF VWC W W/ W/O WC WD WDG WP WPMEM WPT WRB WRGB WS	VERIFY IN FIELD VINYL WALL COVERING WIDE / WIDTH WITH WITHOUT WATER CLOSET WOOD WDG ARCHITECTURE WATERPROOFING WATERPROOF MEMBRANE WORKING POINT WATER RESISTIVE BARRIER WATER RESISTANT GYPSUM BOARD WET STACK

A101 WALL SECTION INDICATOR

SYMBOLS

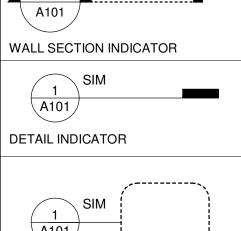

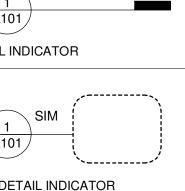

BUILDING SECTION INDICATOR

EXTERIOR ELEVATION INDICATOR

INTERIOR ELEVATION INDICATOR

DOOR NUMBER INDICATOR

1011 ROOM NUMBER

FLOOR AND ROOF TAG INDICATOR

C1 + 1'-0"

(0)—— —

GRID BUBBLE - INDICATES COLUMN LINE

WOOD (ROUGH BLOCKING)

CEILING HEIGHT INDICATOR

HANDICAPPED


▲ OR ▲


ENTRANCE INDICATOR


OR DEMISING LINE


FLOOR NUMBER


1

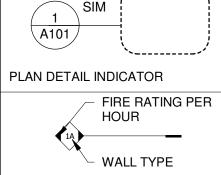

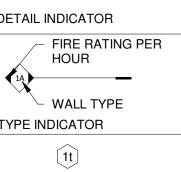

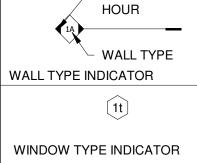


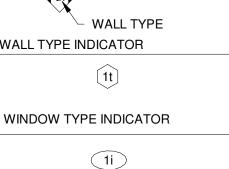

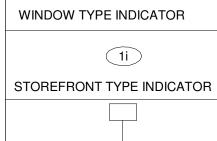

DATUM POINT INDICATOR

LEGEND

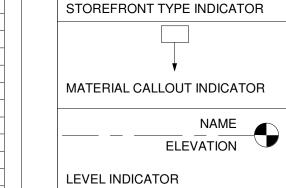

	NEW PARTITION		
======	EXISTING PARTITION TO BE REMOVED		
	BASE BUILDING / EXISTING PARTITION TO REMAIN		
<u> </u>	BATT, THERMAL INSULATION OR SOUND	ATTENUATION BL	anket as detailed
	RIGID THERMAL INSULATION		
	SEMI RIGID THERMAL INSULATION		
	ALUMINUM		GYPSUM BOARD
	BRASS		POROUS FILL (STONE OR GRAVEL)

PROJECT DATA

EXISITNG SITE:

ACCESSOR'S PARCEL SITE ADDRESS

07109000450000

COUNTY OF SACRAMENTO JURIDICTION:

PLAT OF WILLOW CREEK COUNTY SUPERVISOR DISTRICT: **ESTATES SOUTH**

25

RD-3 **USE ZONE:** 19,286 SF TOTAL EXISTING SITE AREA:

LOT NUMBER:

PROPOSED RESIDENCE: OCCUPANCY GROUP & BUILDING USE: R-3 TYPE OF CONSTRUCTION: STORIES: 5,170 SF RESIDENCE + 1,421 SF GARAGE + 1,795 SF BASEMENT + 168 SF BATH HOUSE TOTAL PROPOSED BUILDING AREA:

PROPOSED ADU:

OCCUPANCY GROUP & BUILDING USE: R-3 TYPE OF CONSTRUCTION: STORIES:

992 SF + 578 SF Garage + 341 SF Basement TOTAL PROPOSED BUILDING AREA:

PROPOSED JADU:


OCCUPANCY GROUP & BUILDING USE: R-3 TYPE OF CONSTRUCTION:

STORIES:

TOTAL PROPOSED BUILDING AREA: 500 SF + 279 SF Garage

LOT COVERAGE PERCENTAGE - 29%

VICINITY MAP

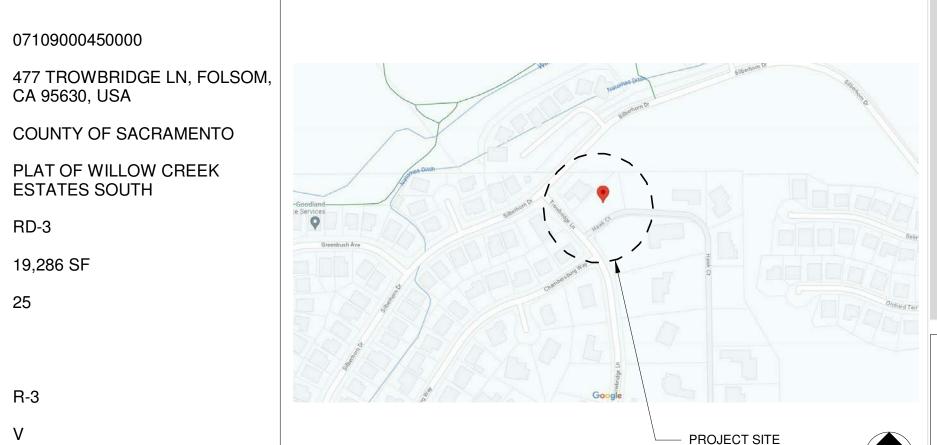

APPLICABLE CODES

2022 CALIFORNIA ADMINISTRATIVE CODE 2022 CALIFORNIA BUILDING CODE 2022 CALIFORNIA RESIDENTIAL CODE 2022 CALIFORNIA ELECTRICAL CODE

2022 CALIFORNIA MECHANICAL CODE 2022 CALIFORNIA PLUMBING CODE

2022 CALIFORNIA BUILDING ENERGY CODE

2022 CALIFORNIA FIRE CODE

2022 CALIFORNIA GREEN BUILDING CODE

PROJECT TEAM

MECH./ ELEC./PLUMB. ENGINEER

KSPN Holdings, LLC 8795 Folsom Blvd, Suite 205 Sacramento, CA 95826 Ph: (510) 459-6284 Email: shameern@meditab.com

<u>ARCHITECT</u> PixelArch Ltd.

STRUCTURAL ENGINEER

Laguna Hills, CA 92653

Email: info@pixelarchltd.com

Ph: (415) 316-7162

PixelArch Ltd. Laguna Hills, CA 92653 Ph: (415) 316-7162 Email: info@pixelarchltd.com

PixelArch Ltd.

24001 Calle De La Magdalena, unit 3896 Laguna Hills, CA 92653 Ph: (415) 316-7162 Email: info@pixelarchltd.com

SITE/ CIVIL ENGINEER PixelArch Ltd. 24001 Calle De La Magdalena, unit 3896 24001 Calle De La Magdalena, unit 3896 Laguna Hills, CA 92653 Ph: (415) 316-7162

Email: info@pixelarchltd.com

GENERAL CONTRACTOR XXXXXX XXXXXXXX XXXXXXXXXXXXXXXXXXXXXX Ph: (xxx) xxx-xxx

PixelArch ltd. Office: 24001 Calle De La Magdalena, unit 3896 Laguna Hills, CA 92653 Tel: (415) 316 7162 info@pixelarchltd.com www.pixelarchltd.com

TROWBRIDGE

4

Revision Notes: Description Date 23/09/07 | Site Plan & Design Review 24/08/28 SPDR Comments

COPYRIGHT THIS DRAWING IS AN INSTRUMENT OF SERVICE AND AS SUCH, REMAINS THE PROPERTY OF PIXELARCH LTD. PERMISSION FOR USE OR REPRODUCTION IS LIMITED AND CAN BE EXTENDED ONLY BY WRITTEN PERMISSION

Drawing Title: **COVER SHEET**

WITH OWNER, PIXELARCH LTD.

As indicated

2024.09.16

A0.0

SHEET INDEX ARCHITECTURAL DRAWINGS

A0.0 COVER SHEET A0.1 GRADING PLAN A0.2 SITE PHOTOGRAPHS

A1.0a SITE PLAN A1.0b LANDSCAPE PLAN

A1.1 BASEMENT & FIRST FLOOR PLAN - MAIN HOUSE A1.2 SECOND & ROOF FLOOR PLAN - MAIN HOUSE A1.3 FLOOR PLANS & ROOF PLAN - ADU


A1.4 FLOOR PLANS, ELEVATIONS & SECTION - BATH HOUSE A2.1 FRONT AND REAR ELEVATIONS - MAIN HOUSE

A2.2 RIGHT AND LEFT ELEVATIONS - MAIN HOUSE A2.3 ELEVATIONS - ADU

A2.4 3D VIEWS A2.5 MATERIAL BOARD


A3.1 SECTIONS - MAIN HOUSE A3.2 SECTIONS - ADU



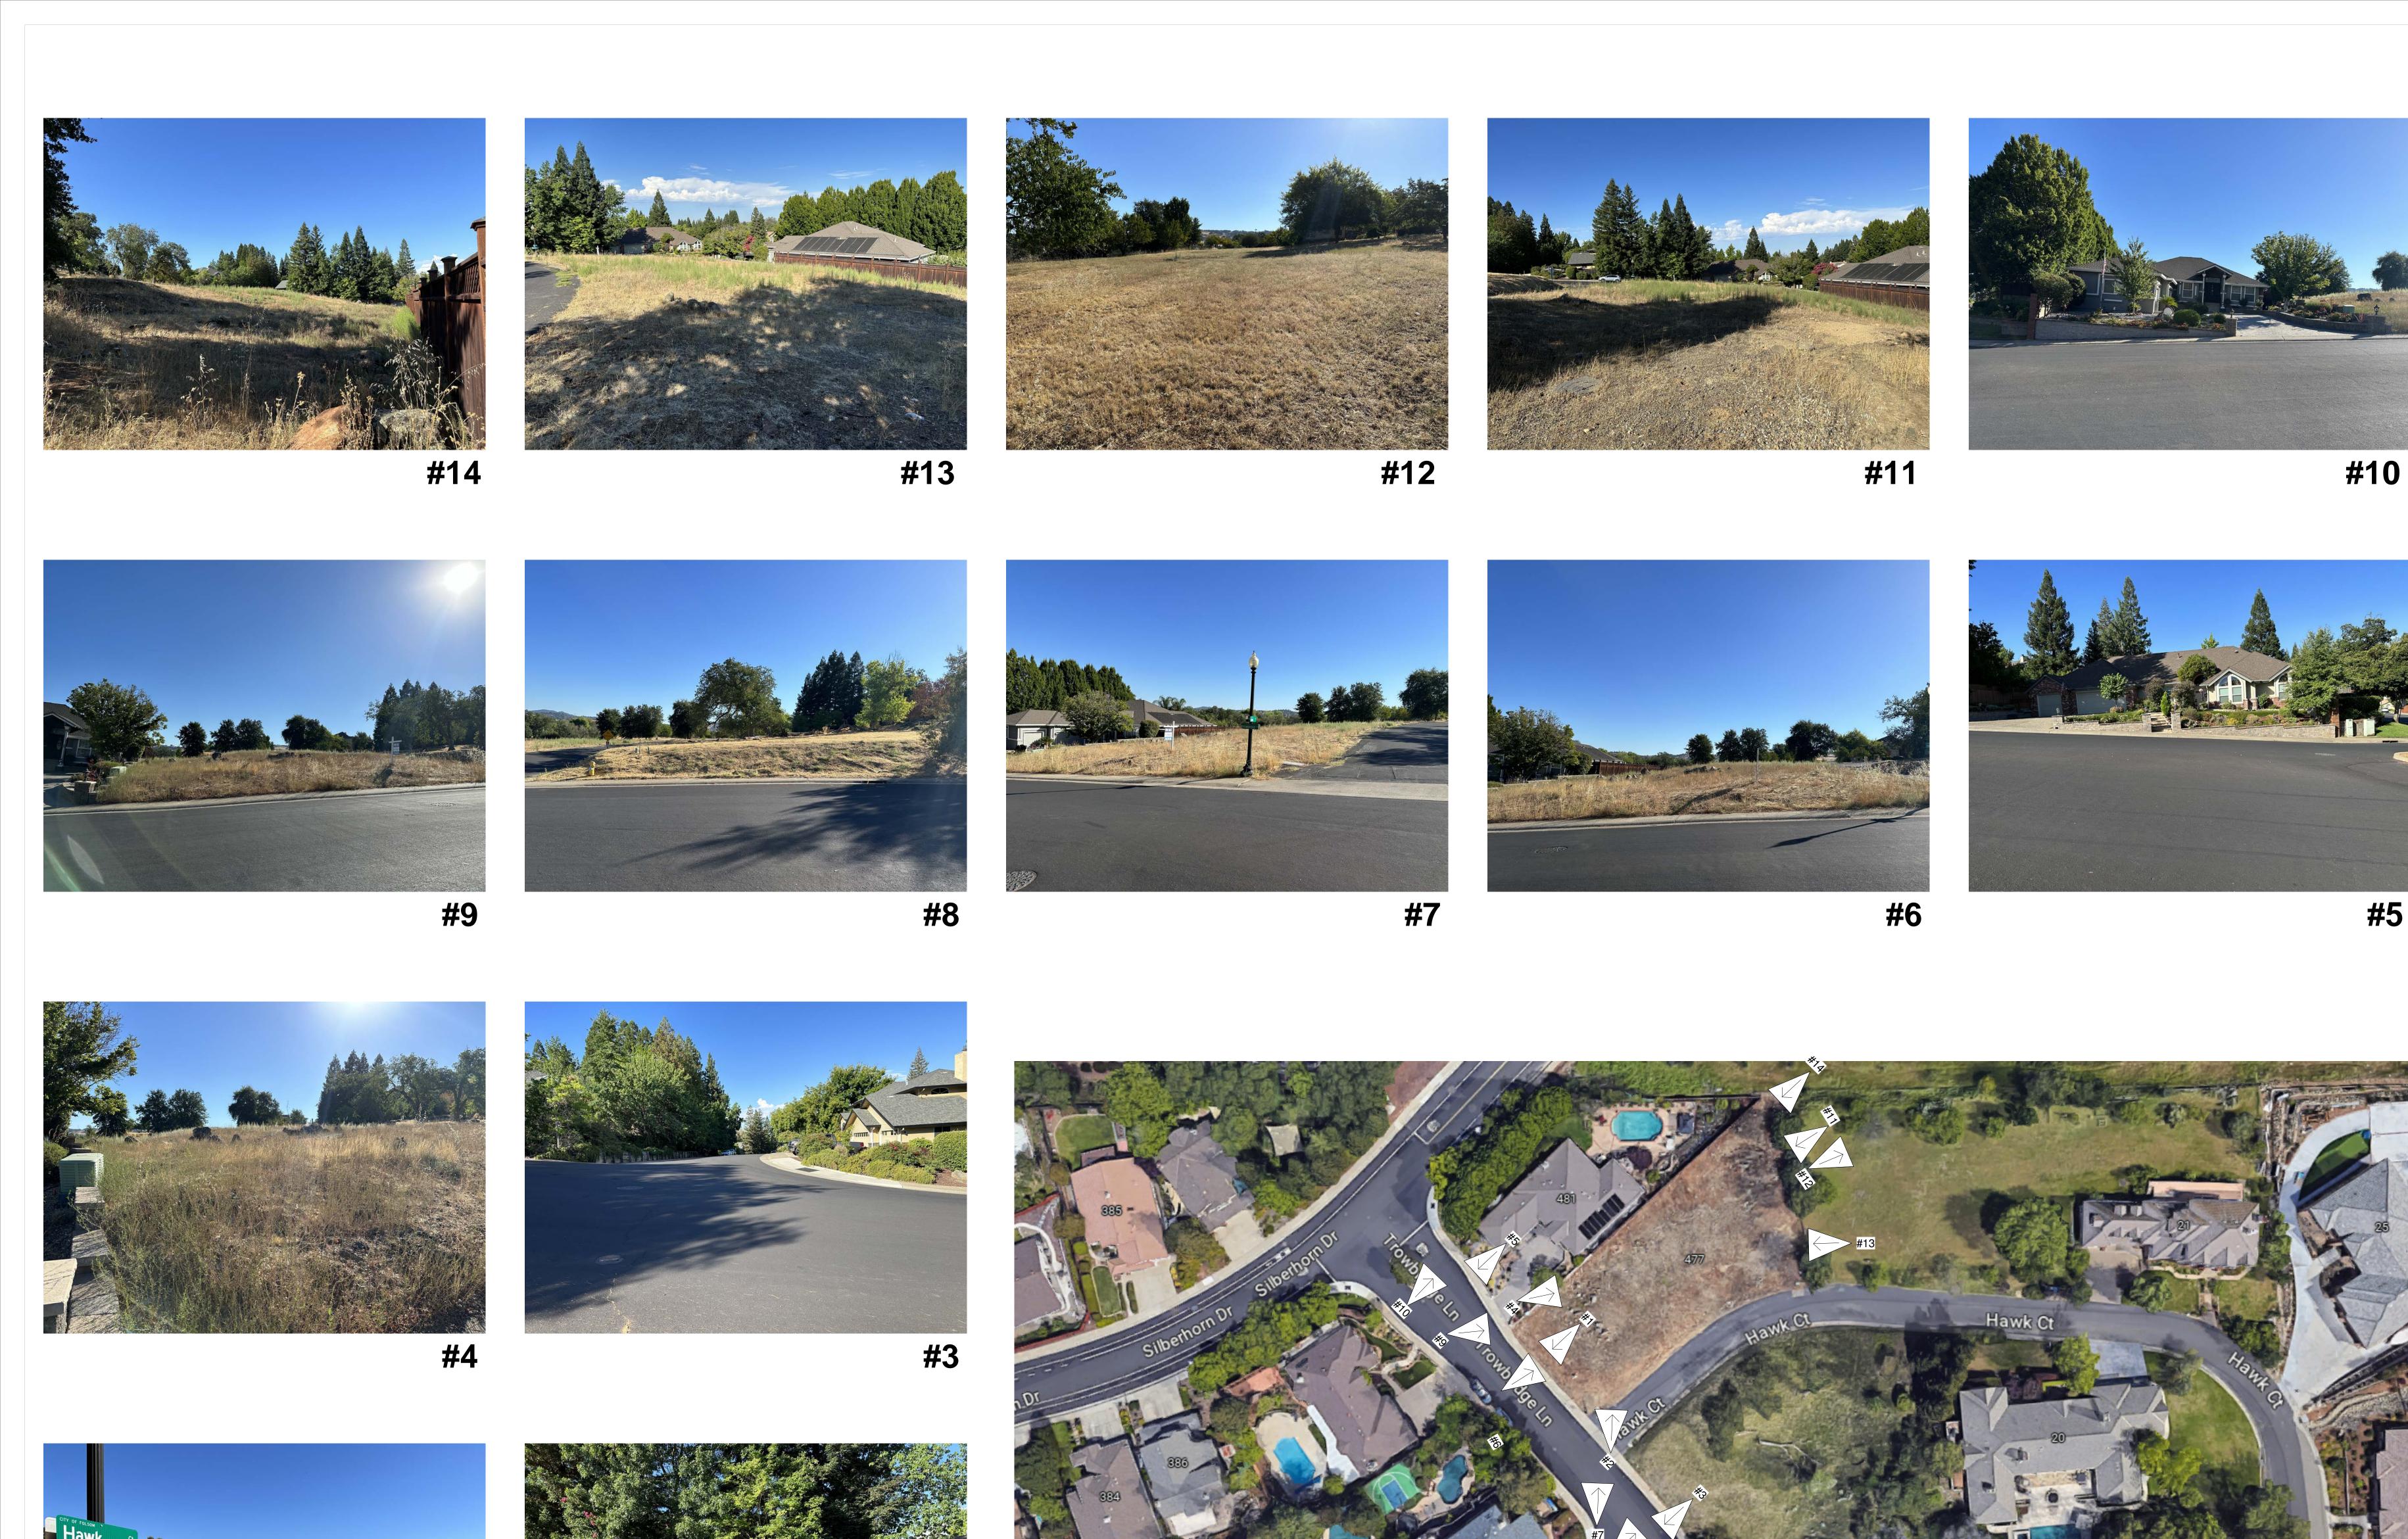

#1

#2

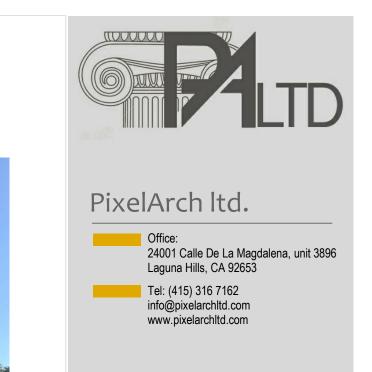

477 TROWBRIDGE LN.
FOLSOM, CA 95630

Revision Notes:

Date Description

23/09/07 Site Plan & Design Review

24/08/28 SPDR Comments

COPYRIGHT
THIS DRAWING IS AN
INSTRUMENT OF SERVICE AND AS

OF PIXELARCH LTD. PERMISSION

FOR USE OR REPRODUCTION IS LIMITED AND CAN BE EXTENDED

ONLY BY WRITTEN PERMISSION

WITH OWNER, PIXELARCH LTD.

SITE PHOTOGRAPHS

1 1/2" = 1'-0"

2024.09.16

No:

A0.2

KEY PLAN

SIDEWALK



7 TROWBRIDGE LN. LSOM, CA 95630

Revision Notes:

Date Description
23/09/07 Site Plan & Design Review
24/08/28 SPDR Comments

23/09/07 Site Plan & Design Review
24/08/28 SPDR Comments

COPYRIGHT
THIS DRAWING IS AN
INSTRUMENT OF SERVICE AND AS
SUCH, REMAINS THE PROPERTY
OF PIXELARCH LTD. PERMISSION
FOR USE OR REPRODUCTION IS
LIMITED AND CAN BE EXTENDED
ONLY BY WRITTEN PERMISSION
WITH OWNER, PIXELARCH LTD.

Drawing Title:

SITE PLAN

1" = 10'-0"

2024.09.16

Page No:

A1.0a

LAWN COVERED SITTING AREA



SWIMMING POOL WITH OUTDOOR KITCHEN AND DINING



DRIVEWAY WITH TREE/SHRUB LINED FENCE



FRONT DRIVEWAY WITH PERMEABLE PAVERS










TREE/SHRUB LINED PATHWAY TO THE BACKYARD



BASKETBALL AND PICKLE BALL COURT

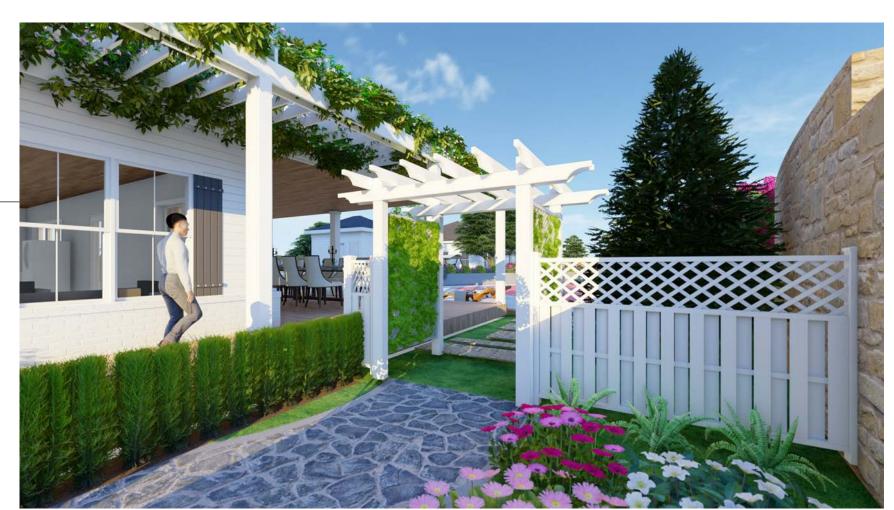

TRELLIS ENTRANCE TO THE BACKYARD



IVY COVERED PAERGOLA



TREE/SHRUB LINED PATHWAY TO THE BACKYARD



PixelArch ltd.

Office:
24001 Calle De La Magdalena, unit 3896
Laguna Hills, CA 92653

Tel: (415) 316 7162
info@pixelarchltd.com
www.pixelarchltd.com

TROWBRIDGE LN.

|

Revision Notes:

Date Description
23/09/07 Site Plan & Design Review
24/08/28 SPDR Comments

COPYRIGHT
THIS DRAWING IS AN
INSTRUMENT OF SERVICE AND AS
SUCH, REMAINS THE PROPERTY
OF PIXELARCH LTD. PERMISSION
FOR USE OR REPRODUCTION IS
LIMITED AND CAN BE EXTENDED
ONLY BY WRITTEN PERMISSION

WITH OWNER, PIXELARCH LTD.

Drawing Title:

LANDSCAPE PLAN


Scale: 1" = 10'-0"


te: 2024.09.16


ge No:

A1.0b

OATE:11-10-2024 20:03:00

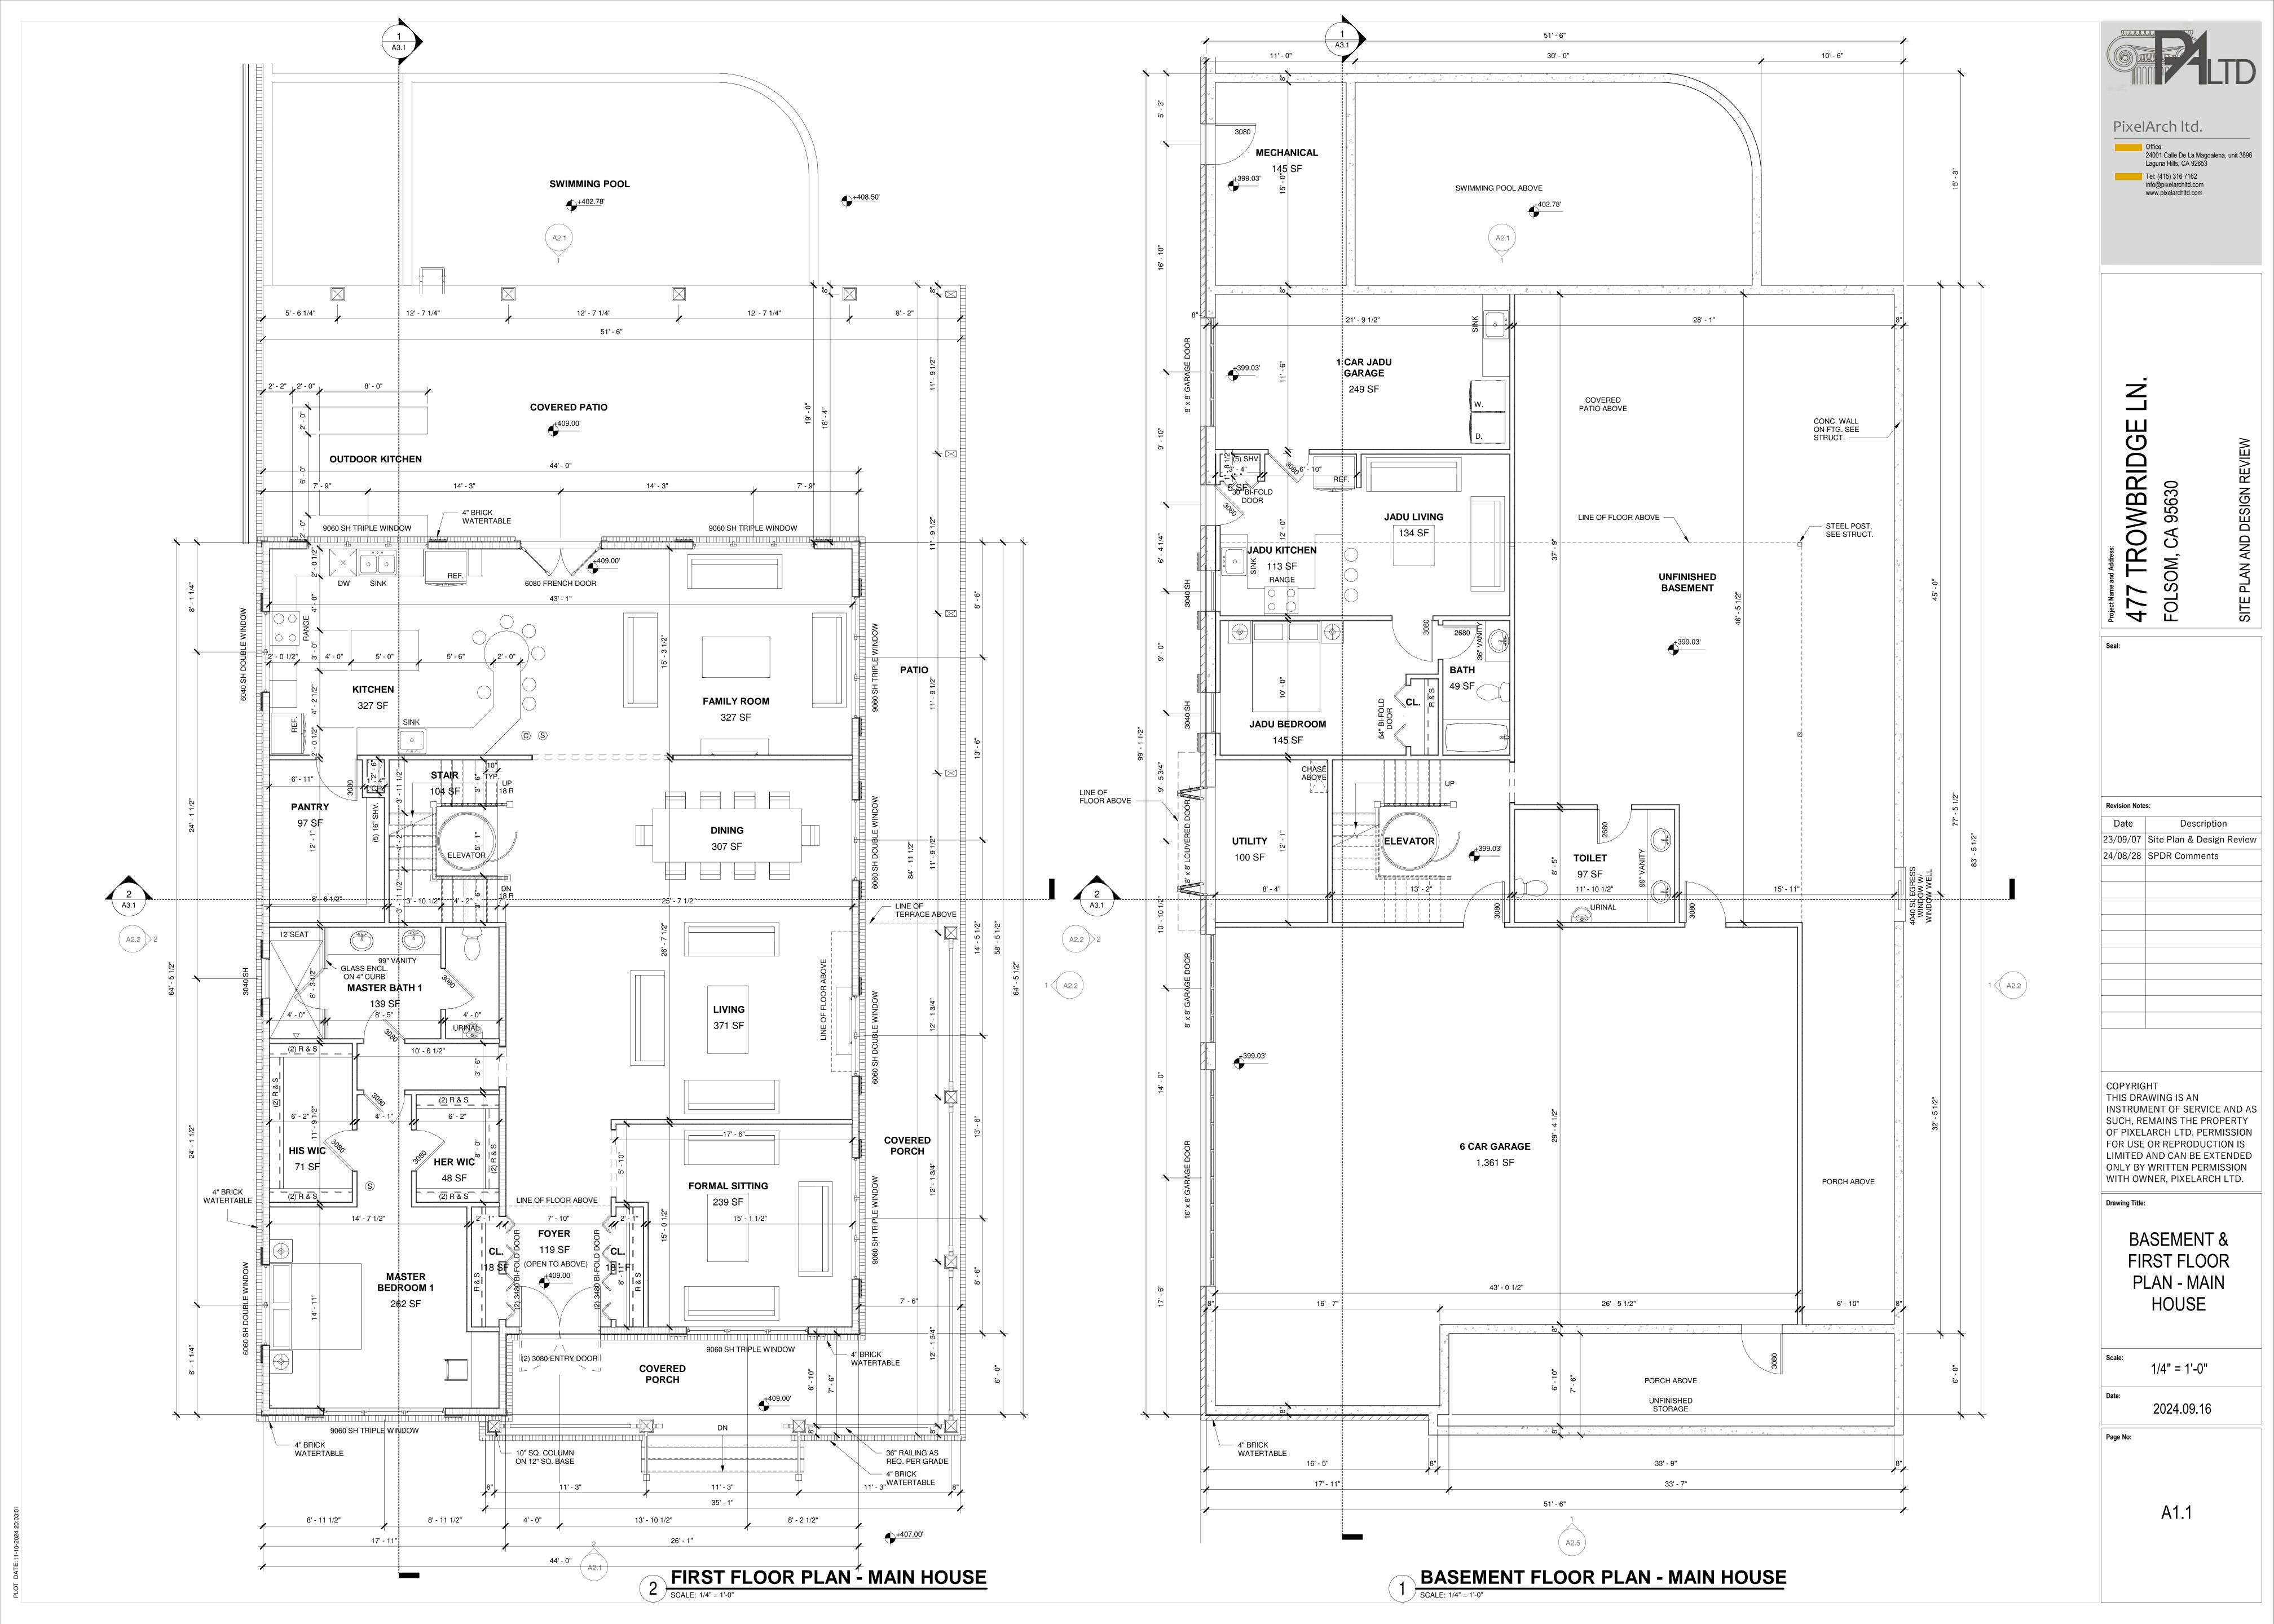

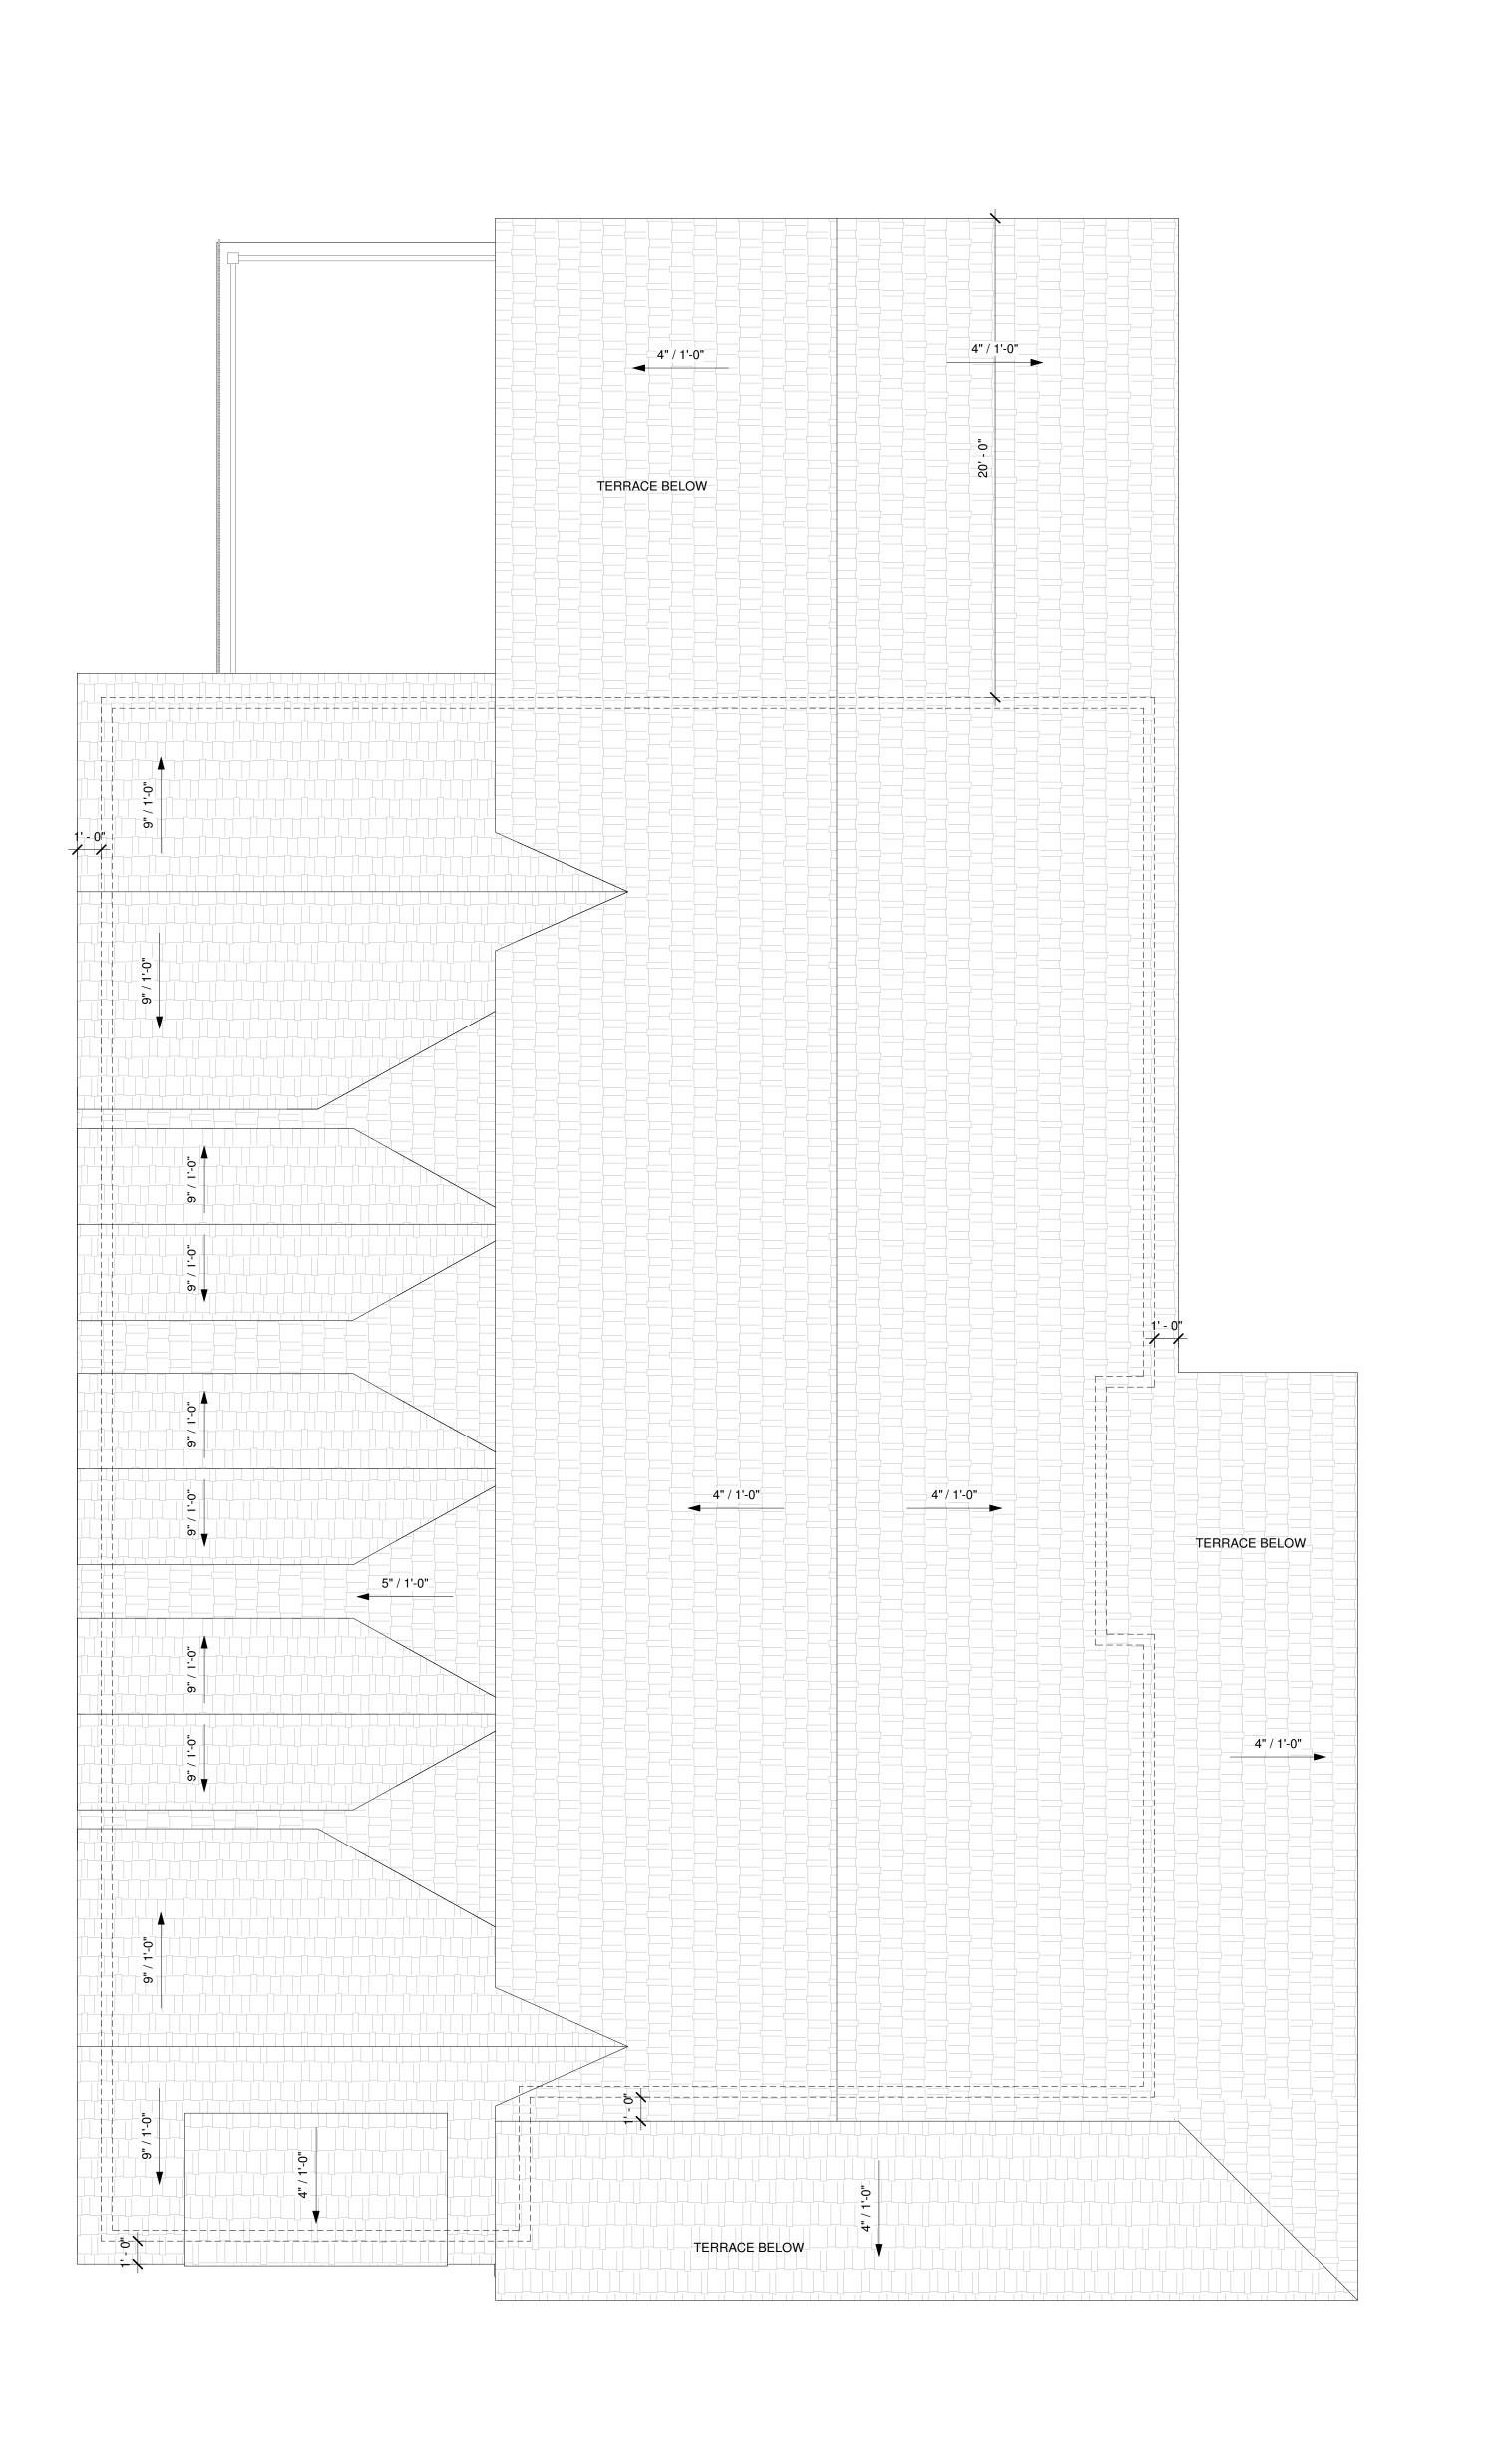

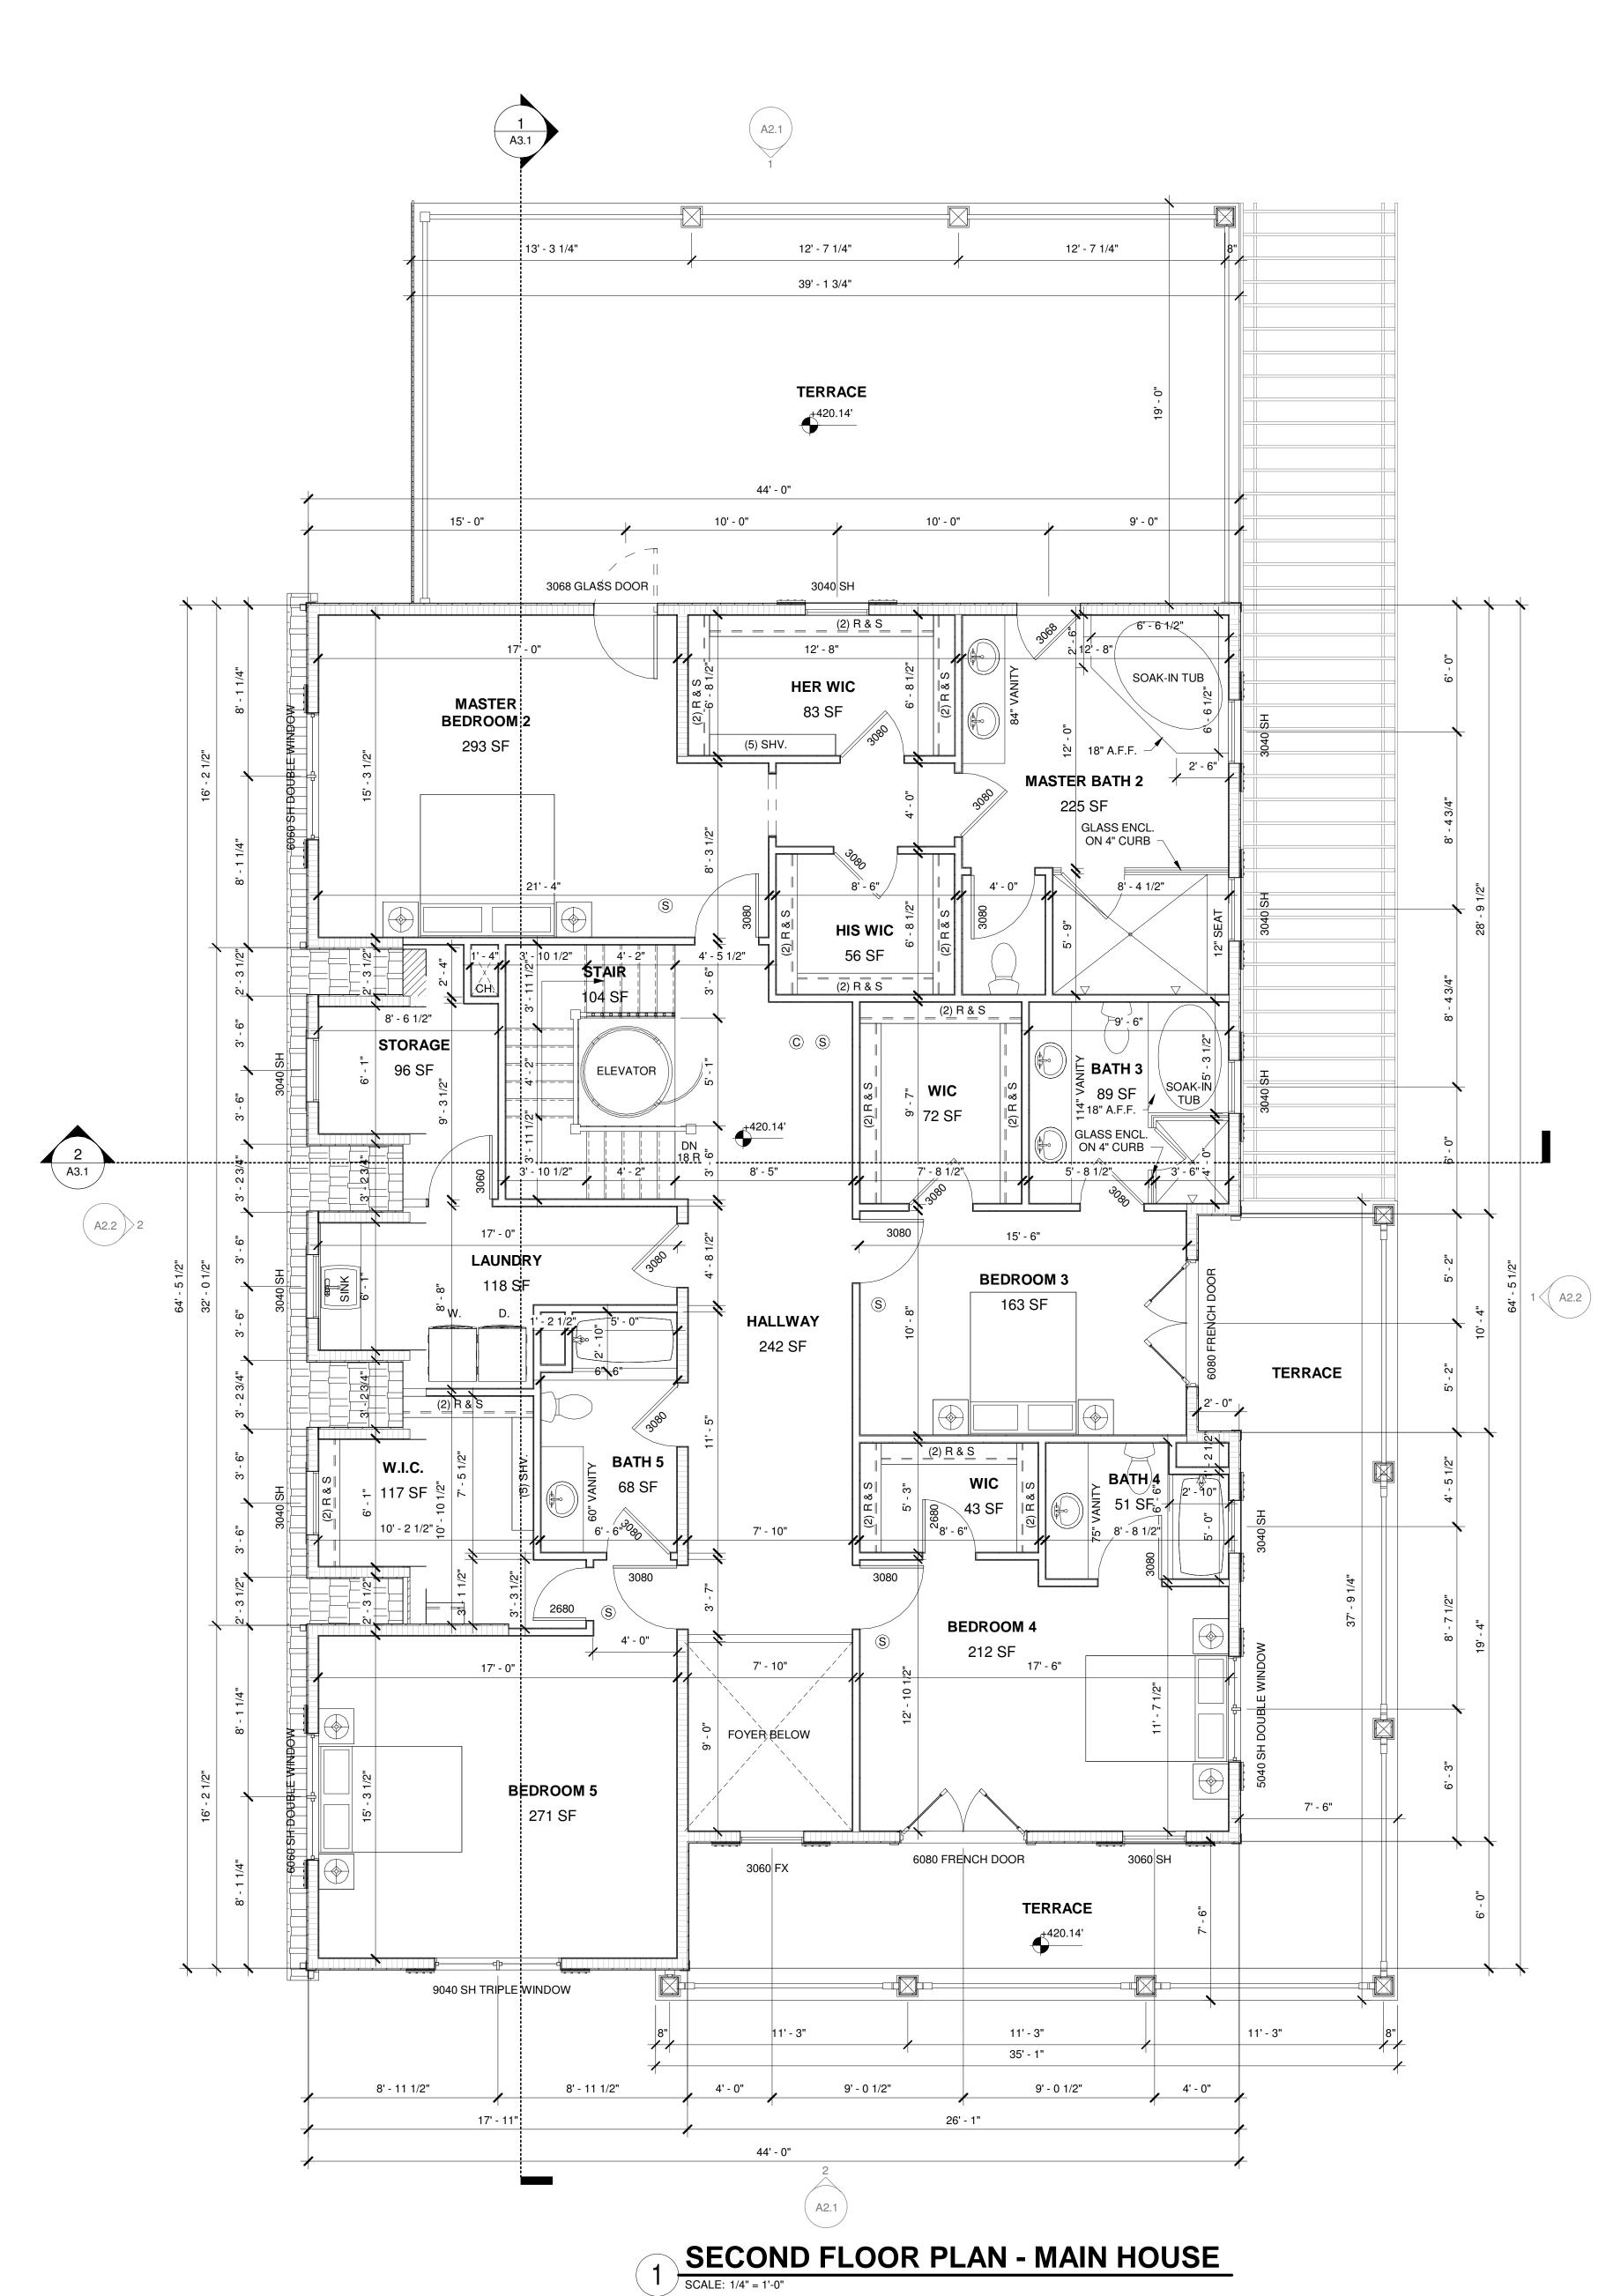

PixelArch Itd.

Office:
24001 Calle De La Magdalena, unit 3896
Laguna Hills, CA 92653

Tel: (415) 316 7162
info@pixelarchltd.com
www.pixelarchltd.com

77 TROWBRIDGE LN. OLSOM, CA 95630

Revision Notes:

Date Description
23/09/07 Site Plan & Design Review
24/08/28 SPDR Comments

24/08/28 SPDR Comments

COPYRIGHT
THIS DRAWING IS AN
INSTRUMENT OF SERVICE AND AS
SUCH, REMAINS THE PROPERTY
OF PIXELARCH LTD. PERMISSION
FOR USE OR REPRODUCTION IS
LIMITED AND CAN BE EXTENDED
ONLY BY WRITTEN PERMISSION
WITH OWNER, PIXELARCH LTD.

Drawing Title:


SECOND & ROOF FLOOR PLAN - MAIN HOUSE

Scale: 1/4" = 1'-0"


^{e:} 2024.09.16

Page No:

A1.2

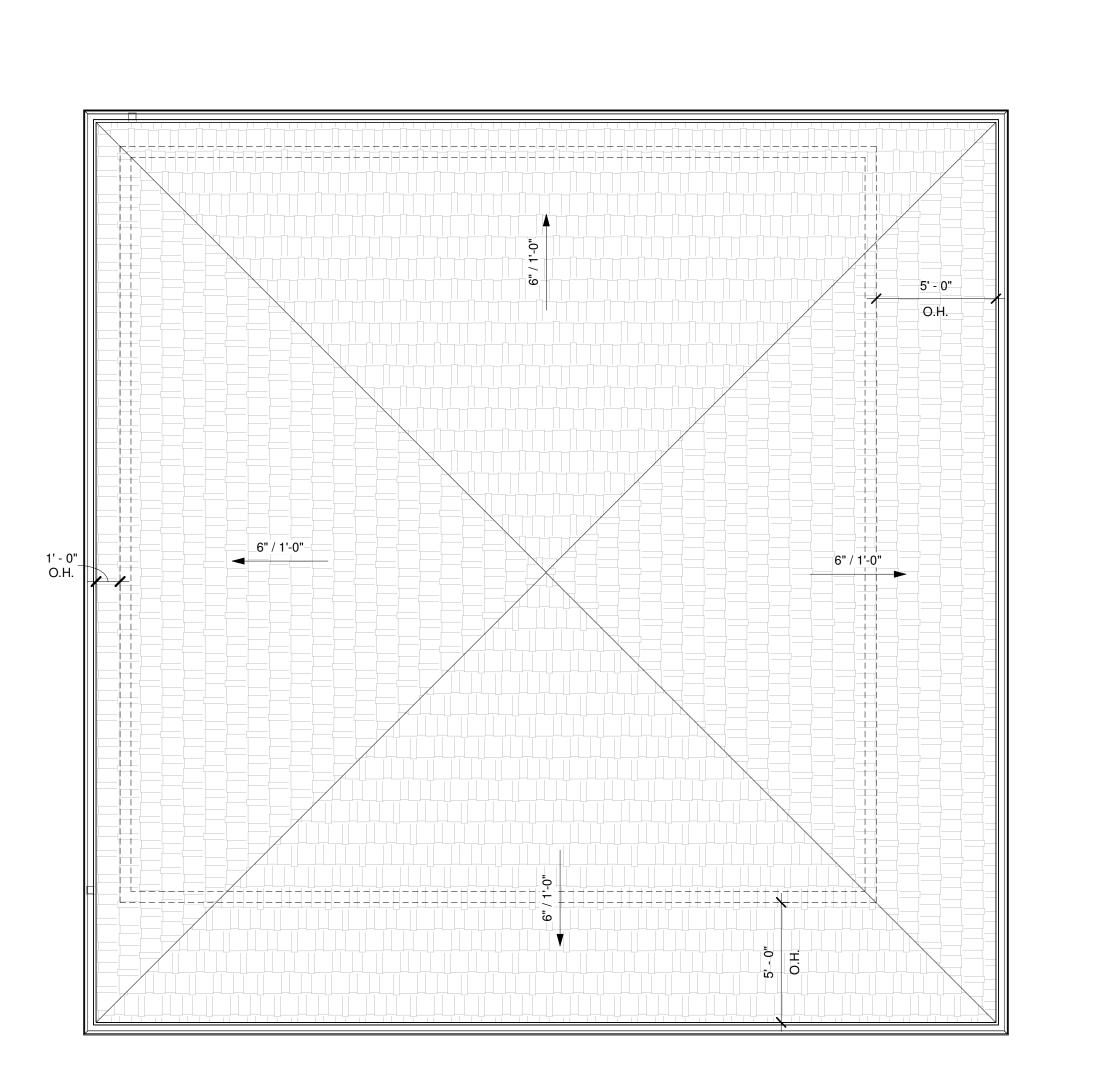


3 ROOF PLAN - ADU SCALE: 1/4" = 1'-0"

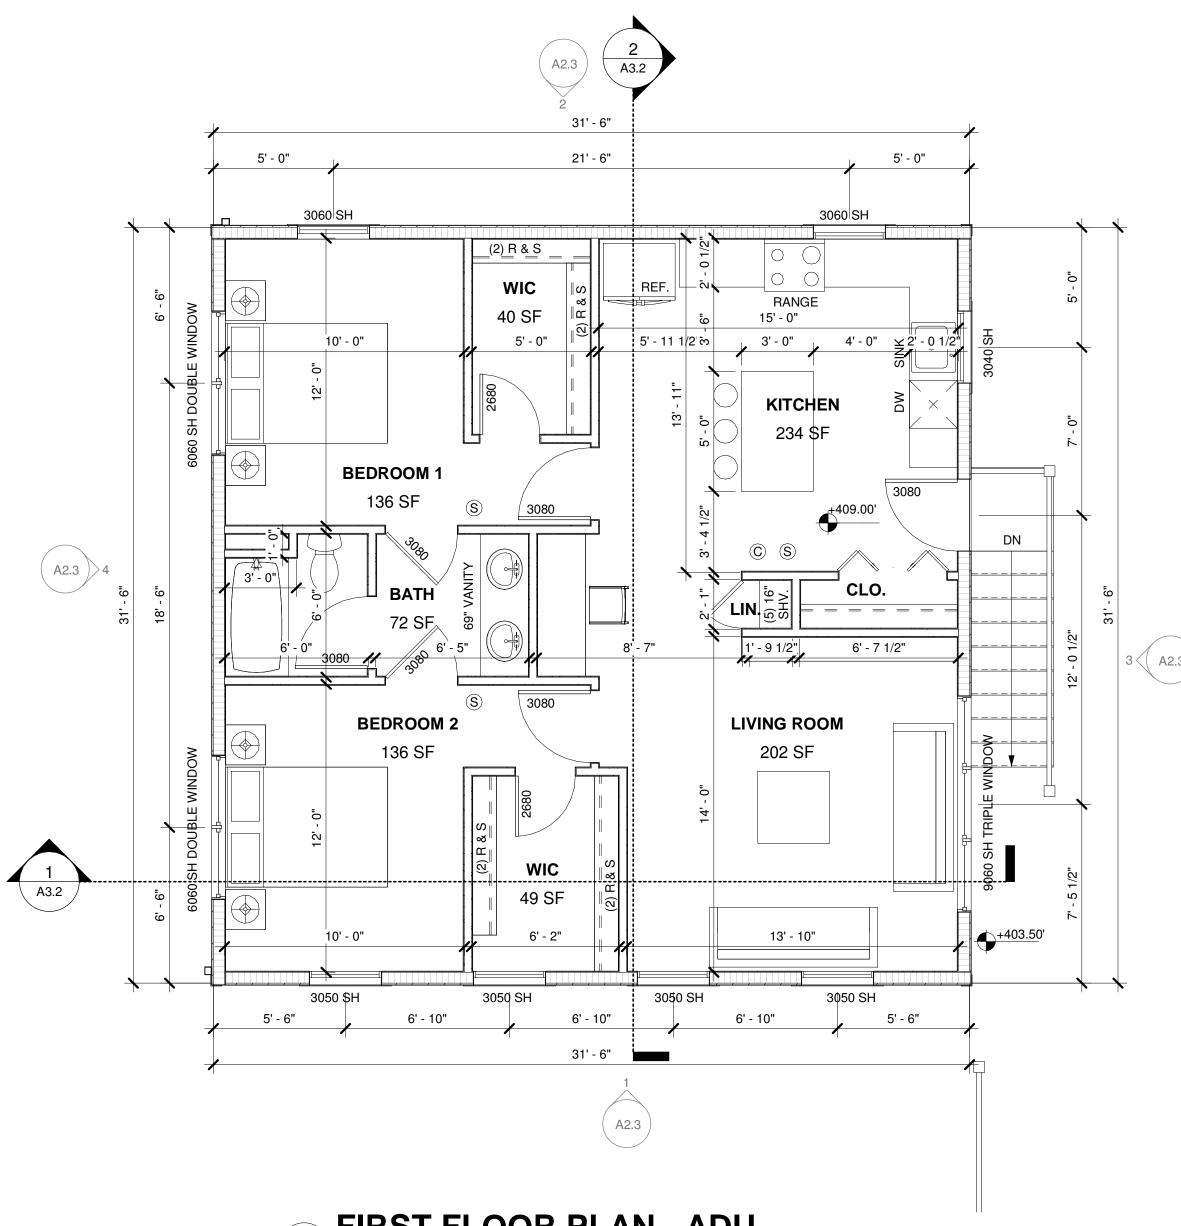

FIRST FLOOR PLAN - ADU

SCALE: 1/4" = 1'-0"

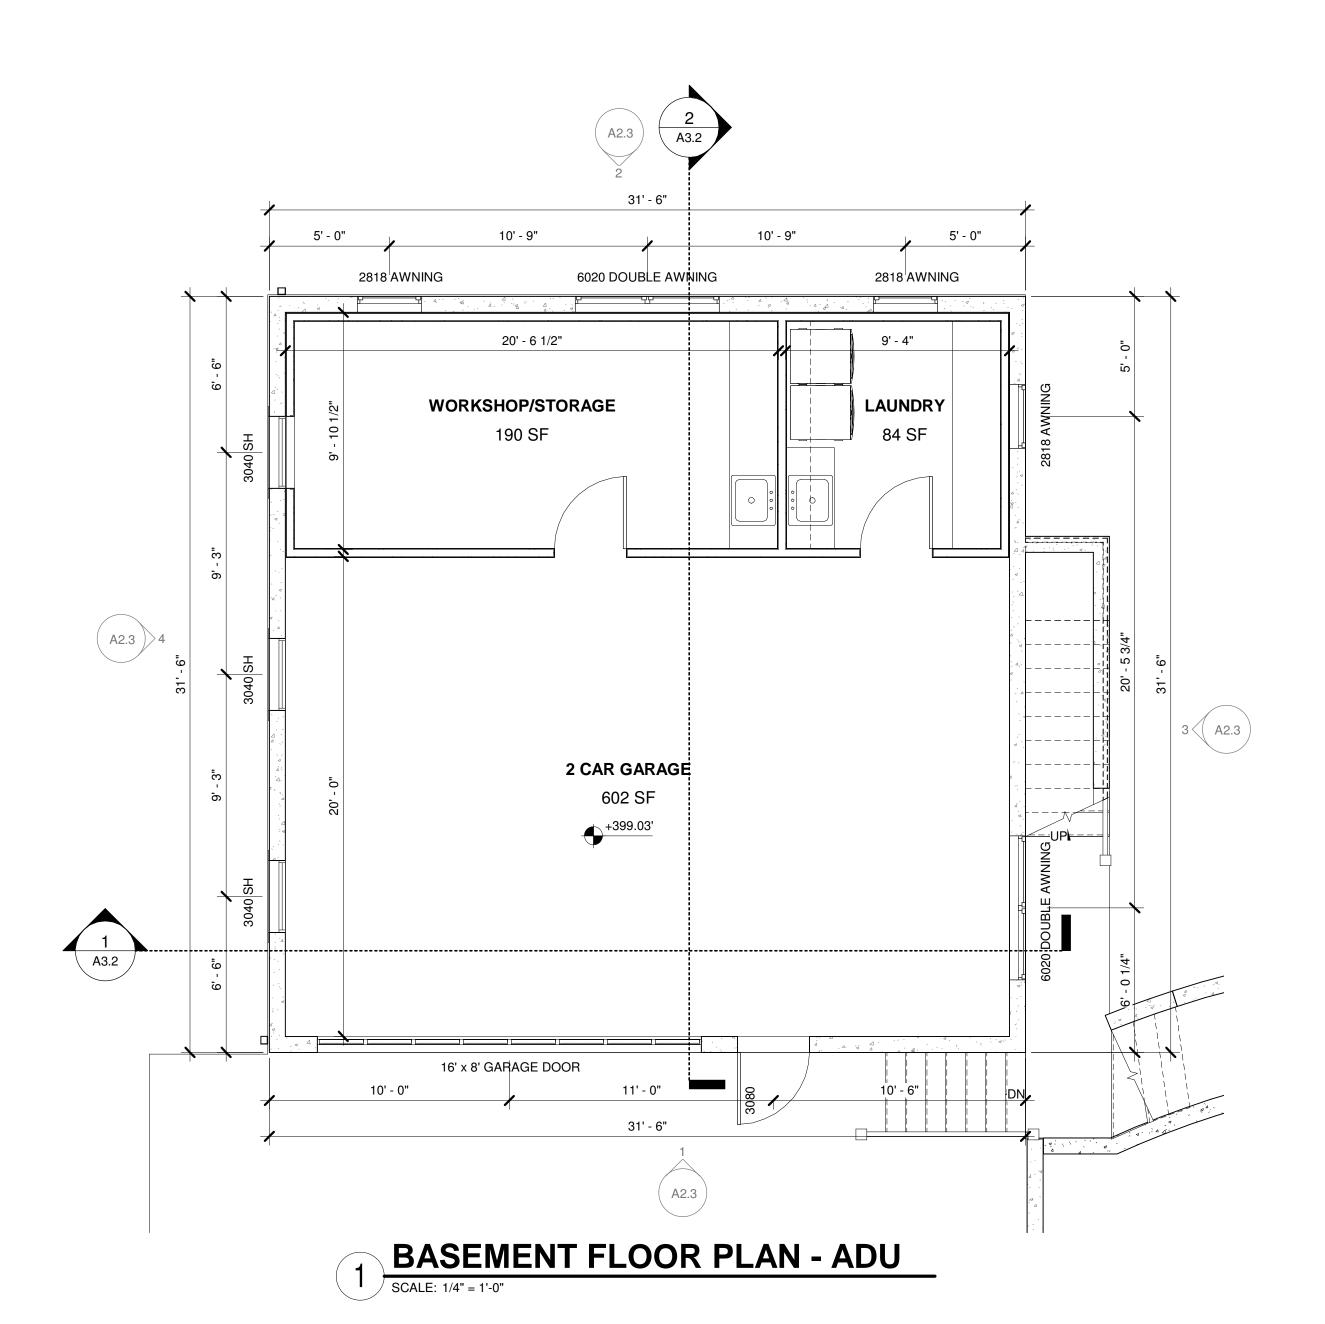

PixelArch ltd.

Office: 24001 Calle De La Magdalena, unit 3896 Laguna Hills, CA 92653 Tel: (415) 316 7162 info@pixelarchltd.com www.pixelarchltd.com

TROWBRIDGE LN

Revision Notes: Description 23/09/07 Site Plan & Design Review 24/08/28 SPDR Comments

COPYRIGHT THIS DRAWING IS AN INSTRUMENT OF SERVICE AND AS SUCH, REMAINS THE PROPERTY OF PIXELARCH LTD. PERMISSION FOR USE OR REPRODUCTION IS LIMITED AND CAN BE EXTENDED ONLY BY WRITTEN PERMISSION WITH OWNER, PIXELARCH LTD.


Drawing Title:

FLOOR PLANS & ROOF PLAN -


1/4" = 1'-0"

2024.09.16


A1.3

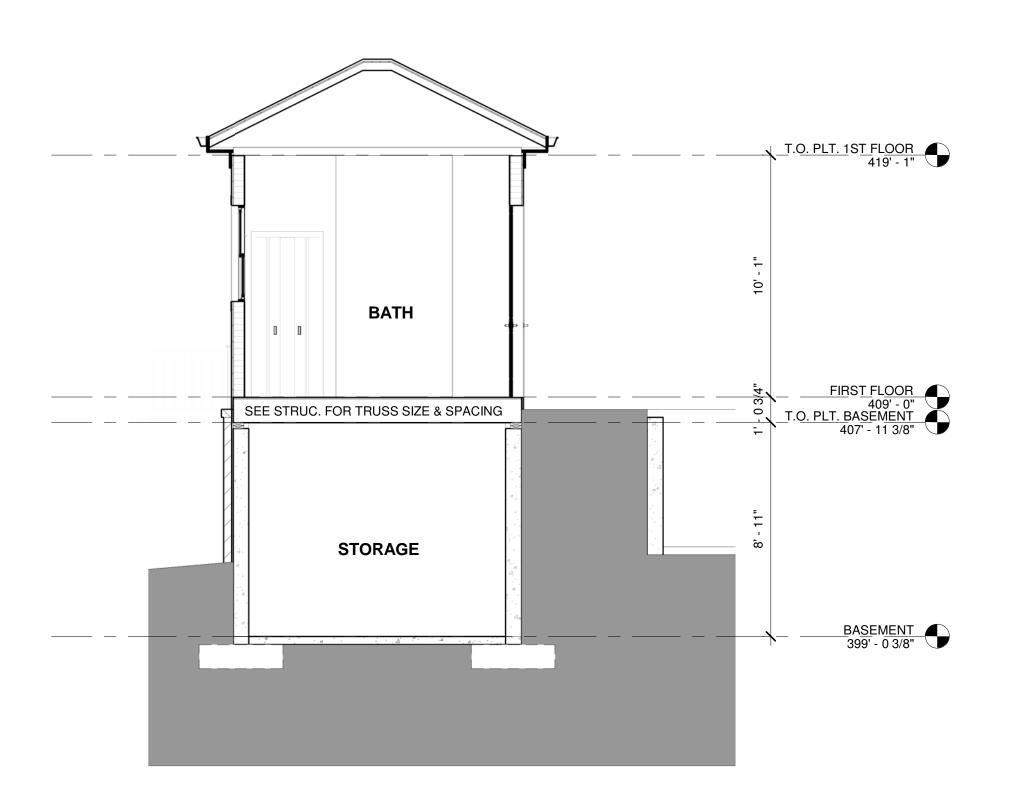


8 SCALE: 1/4" = 1'-0"

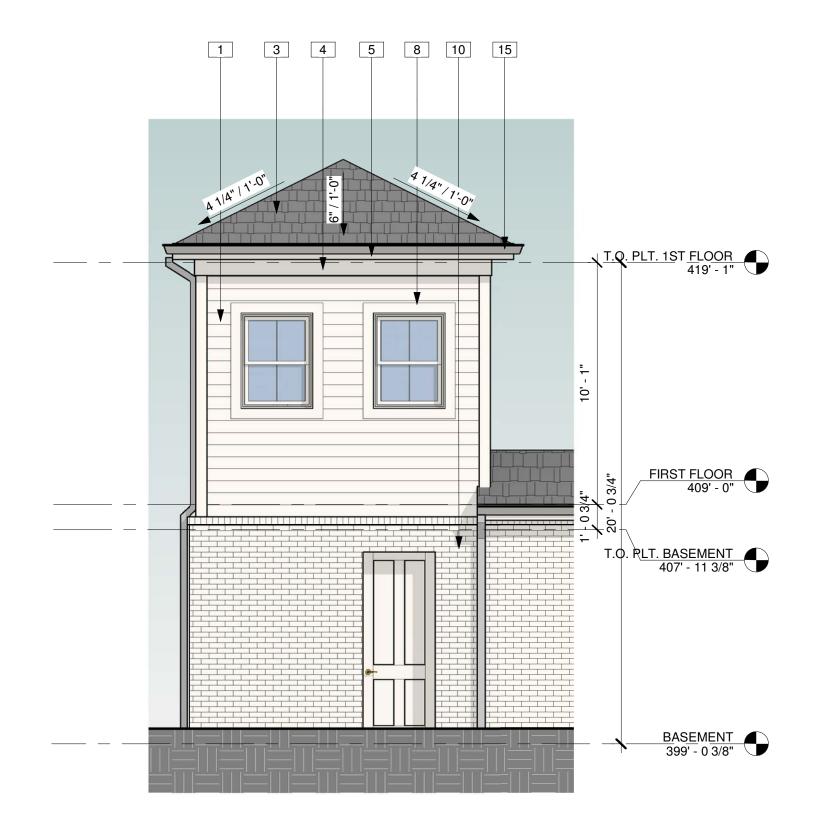




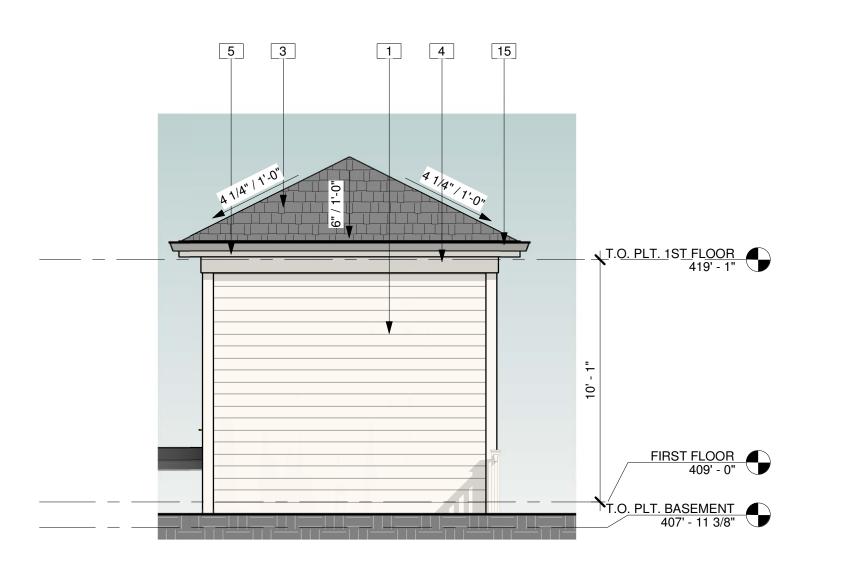

SCALE: 1/4" = 1'-0"

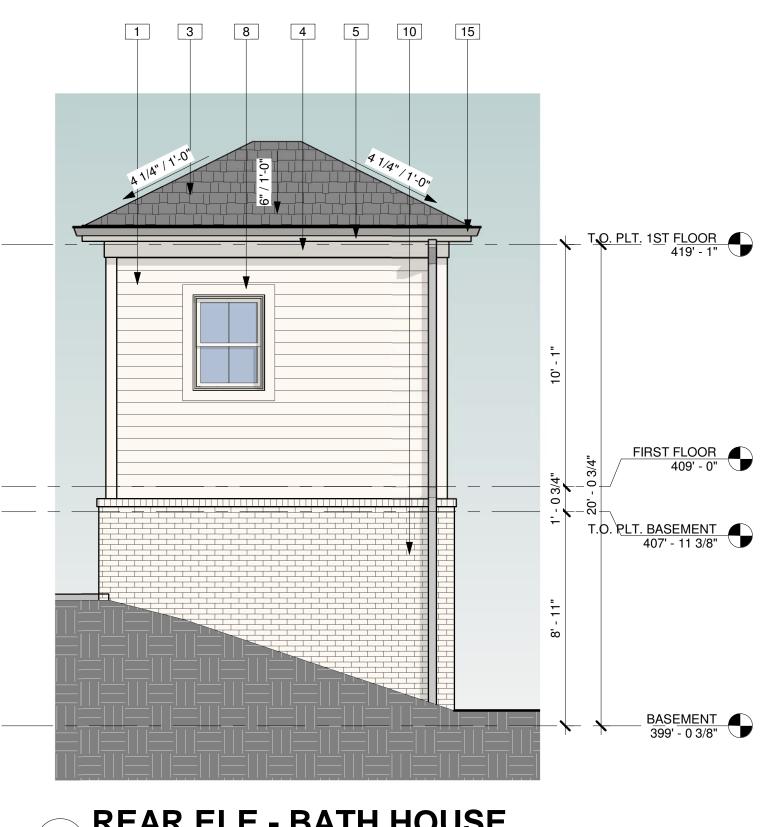


6 REAR ELE - BATH HOUSE
SCALE: 1/4" = 1'-0"

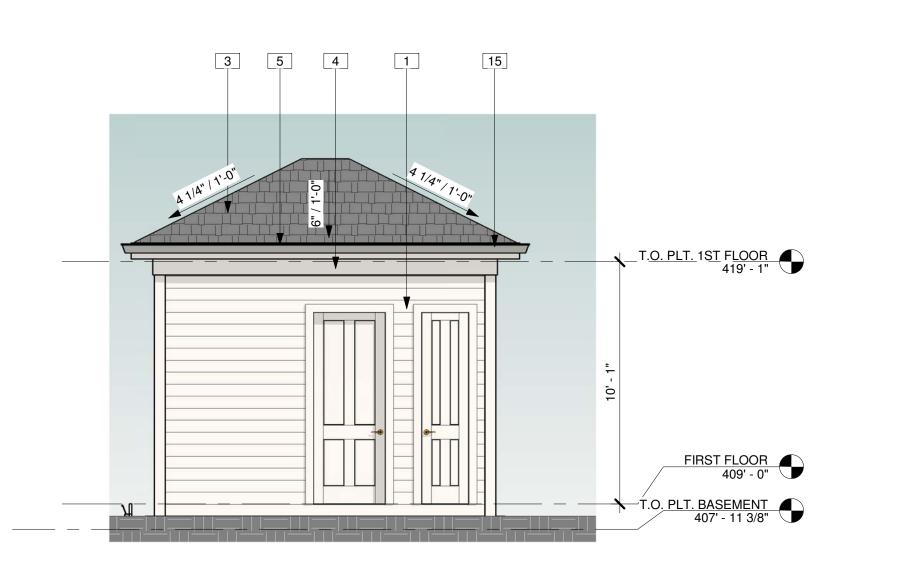


FRONT ELE - BATH HOUSE

SCALE: 1/4" = 1'-0"

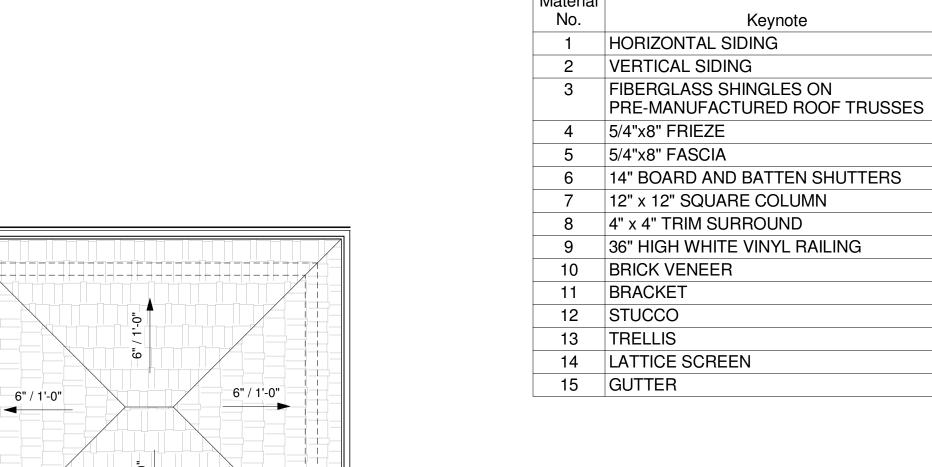


EXTERIOR ELEVATION SCHEDULE

3 ROOF PLAN - BATH HOUSE SCALE: 1/4" = 1'-0"

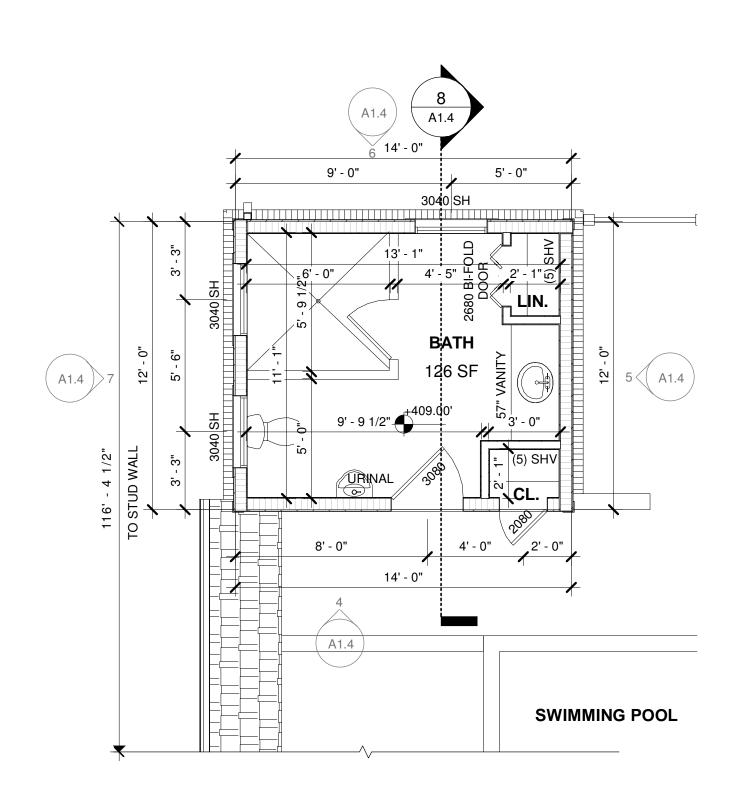

PIRST FLOOR PLAN - BATH HOUSE SCALE: 1/4" = 1'-0"

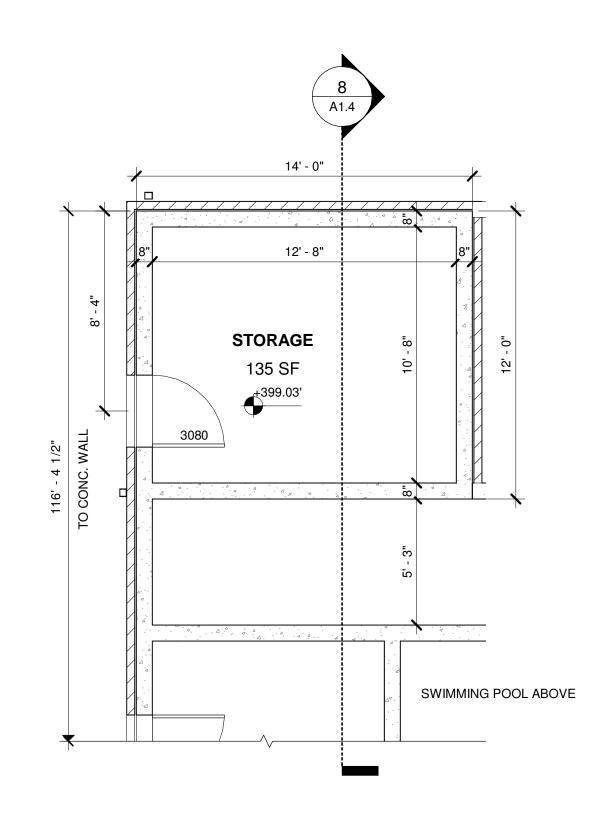

BASEMENT FLOOR PLAN - BATH HOUSE



Office:
24001 Calle De La Magdalena, unit 3896
Laguna Hills, CA 92653

Tel: (415) 316 7162
info@pixelarchltd.com
www.pixelarchltd.com

477 TROWBRIDGE LN. FOLSOM, CA 95630

sion Note	s:
ate	Description
09/07	Site Plan & Design Review
08/28	SPDR Comments

COPYRIGHT
THIS DRAWING IS AN
INSTRUMENT OF SERVICE AND AS
SUCH, REMAINS THE PROPERTY
OF PIXELARCH LTD. PERMISSION
FOR USE OR REPRODUCTION IS
LIMITED AND CAN BE EXTENDED
ONLY BY WRITTEN PERMISSION
WITH OWNER, PIXELARCH LTD.

Drawing Title:

FLOOR PLANS, ELEVATIONS & SECTION - BATH HOUSE

Scale: 1/4" = 1'-0"


te: 2024.09.16

Page No:

A1.4



PRONT ELEVATION - MAIN BUILDING SCALE: 1/4" = 1'-0"

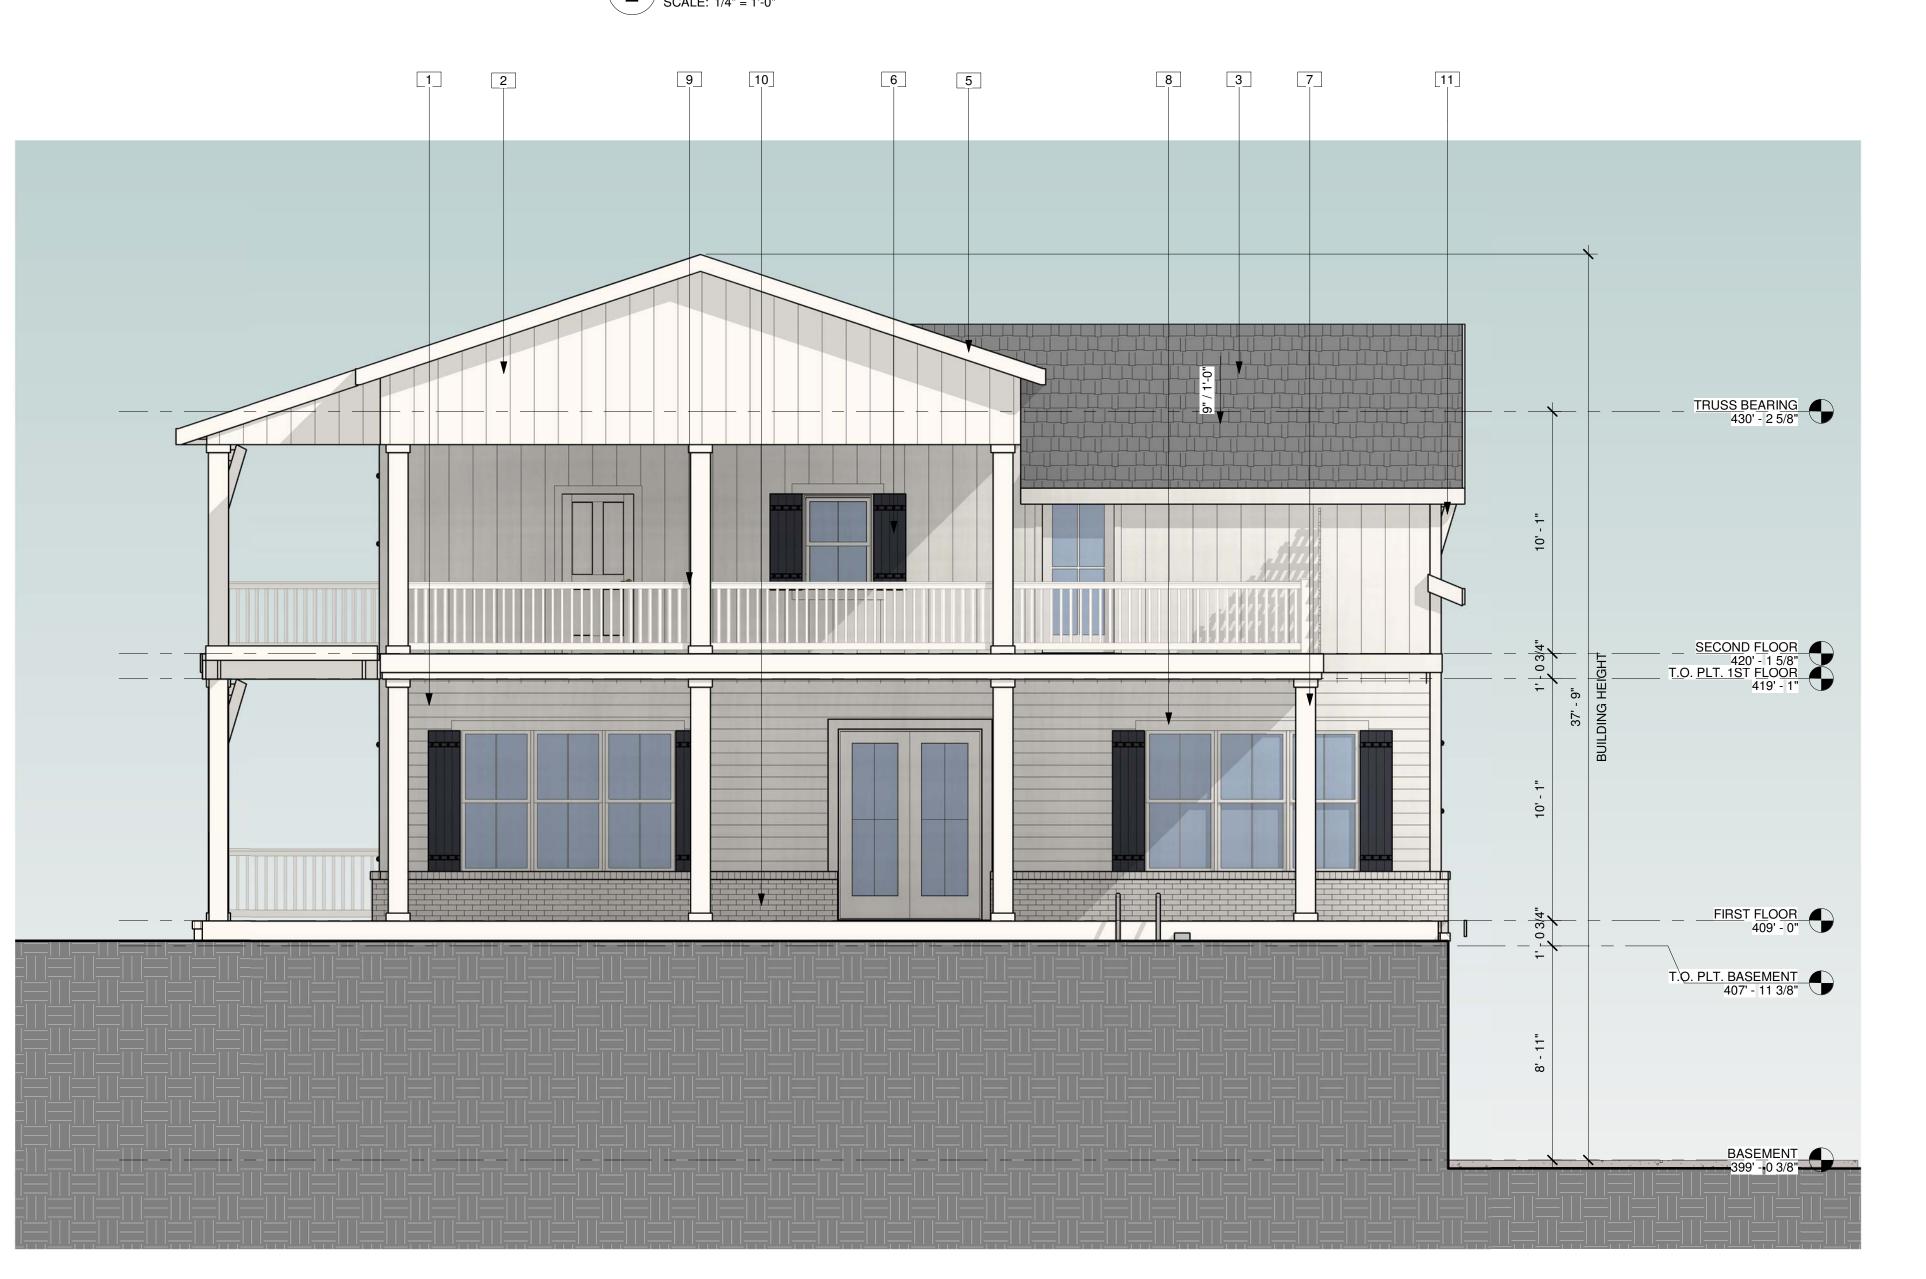

EXTERIOR ELEVATION SCHEDULE

Keynote

1 HORIZONTAL SIDING 2 VERTICAL SIDING

3 FIBERGLASS SHINGLES ON PRE-MANUFACTURED ROOF TRUSSES

4 5/4"x8" FRIEZE

5 5/4"x8" FASCIA 6 14" BOARD AND BATTEN SHUTTERS

7 12" x 12" SQUARE COLUMN 8 4" x 4" TRIM SURROUND

9 36" HIGH WHITE VINYL RAILING

10 BRICK VENEER 11 BRACKET

12 STUCCO

15 GUTTER

13 TRELLIS 14 LATTICE SCREEN PixelArch ltd. Office: 24001 Calle De La Magdalena, unit 3896 Laguna Hills, CA 92653 Tel: (415) 316 7162 info@pixelarchltd.com www.pixelarchltd.com

TROWBRIDGE 47

vision Note	s:
Date	Description
09/07	Site Plan & Design Review

	_

24/08/28 SPDR Comments


COPYRIGHT THIS DRAWING IS AN INSTRUMENT OF SERVICE AND AS SUCH, REMAINS THE PROPERTY OF PIXELARCH LTD. PERMISSION FOR USE OR REPRODUCTION IS LIMITED AND CAN BE EXTENDED ONLY BY WRITTEN PERMISSION WITH OWNER, PIXELARCH LTD.

Drawing Title:


FRONT AND REAR **ELEVATIONS -**MAIN HOUSE

1/4" = 1'-0" 2024.09.16

A2.1

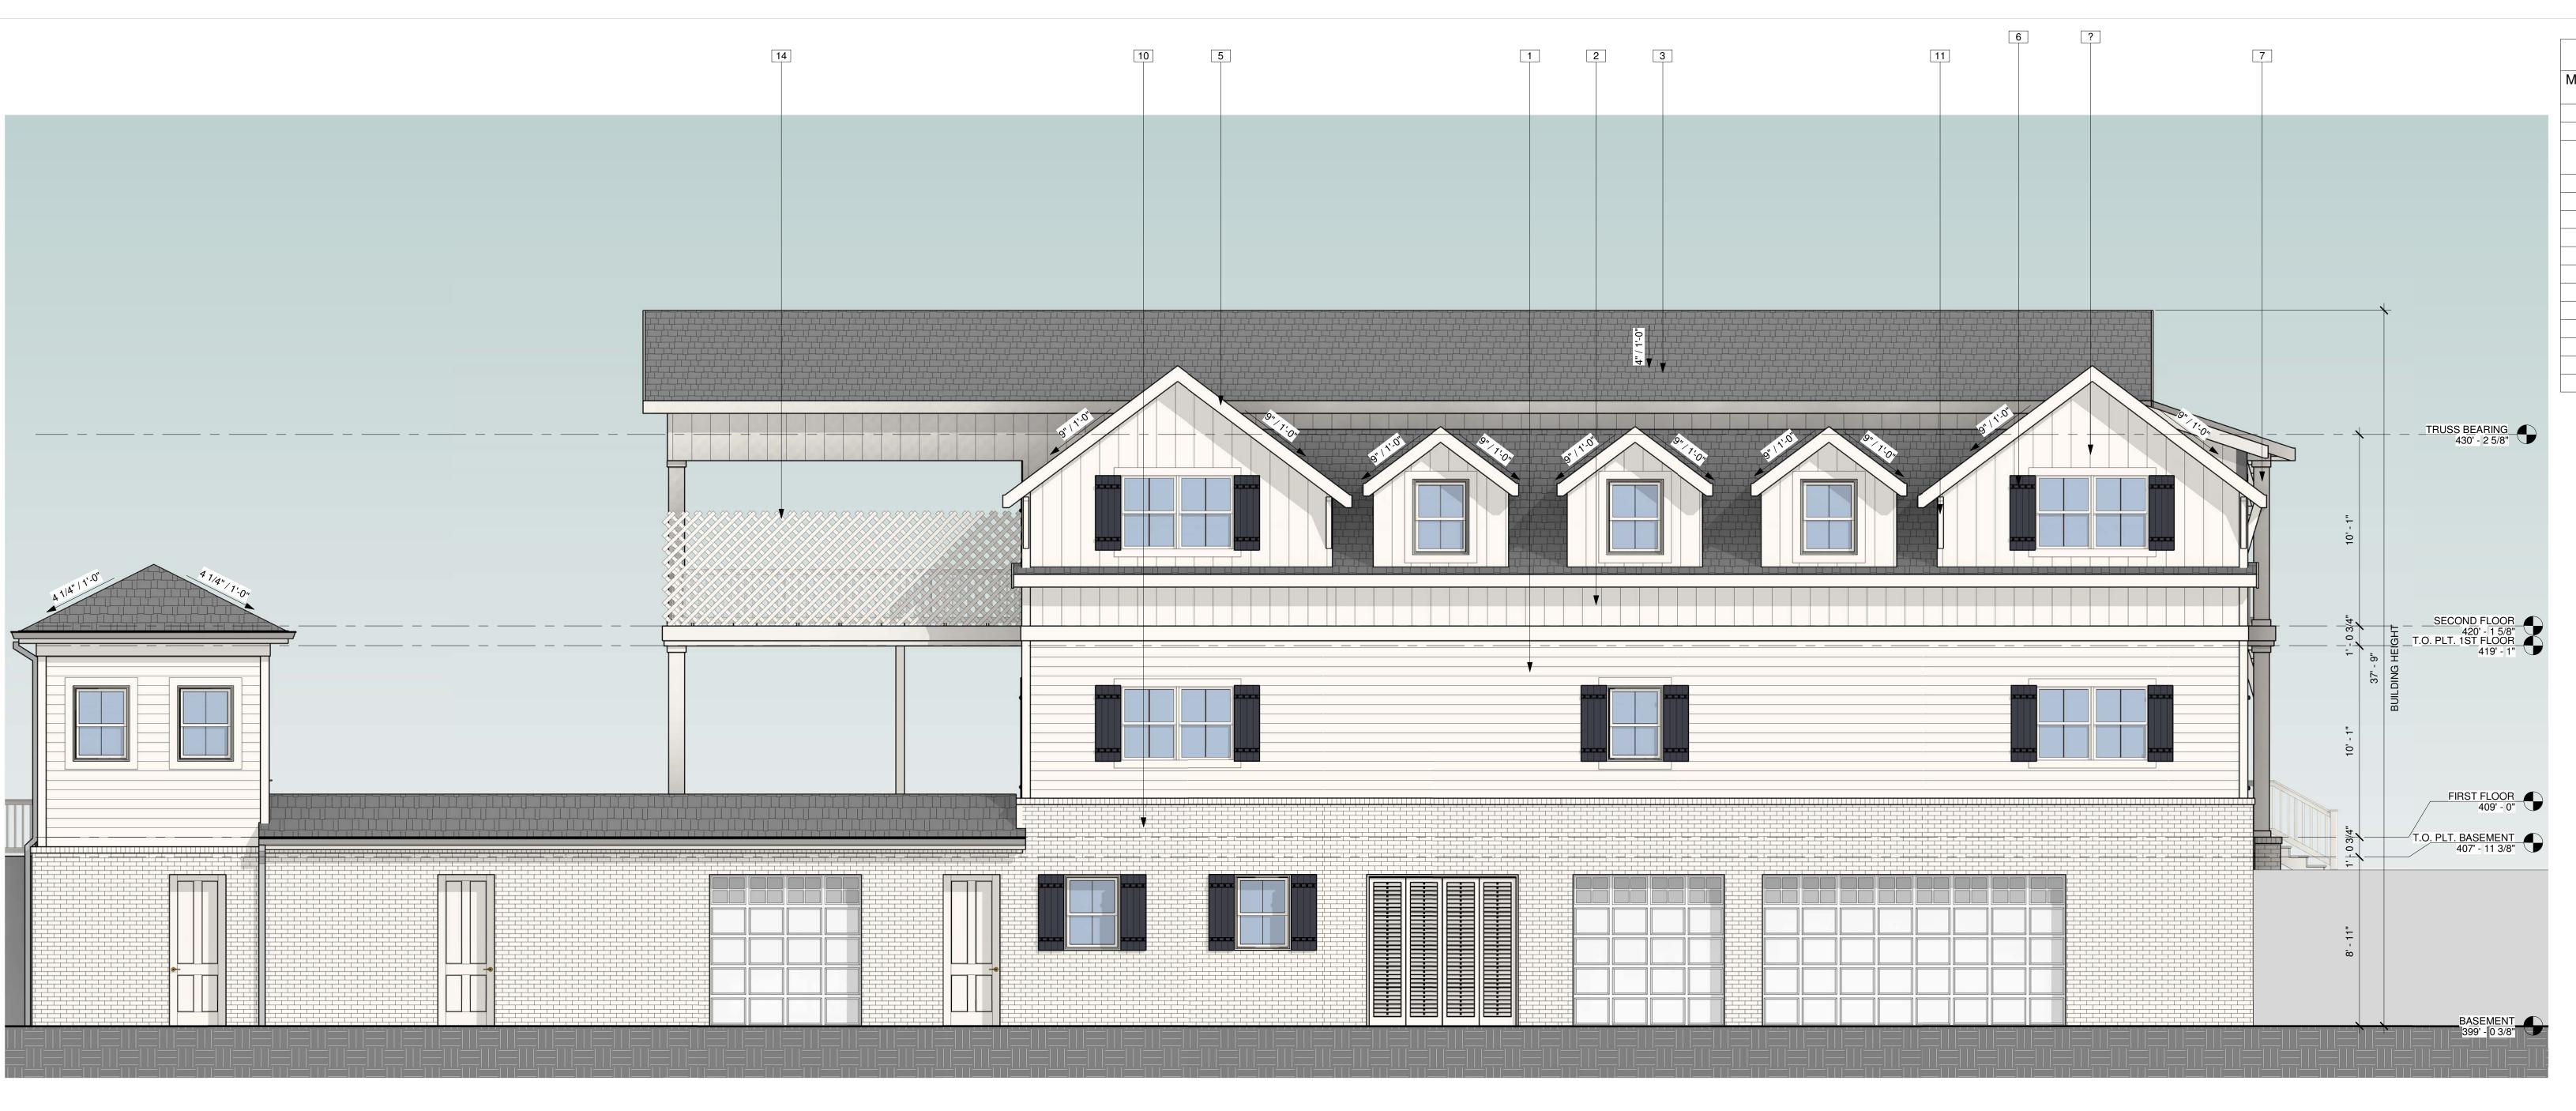

2 WEST SIDE ELEVATION - MAIN BUILDING SCALE: 1/4" = 1'-0"

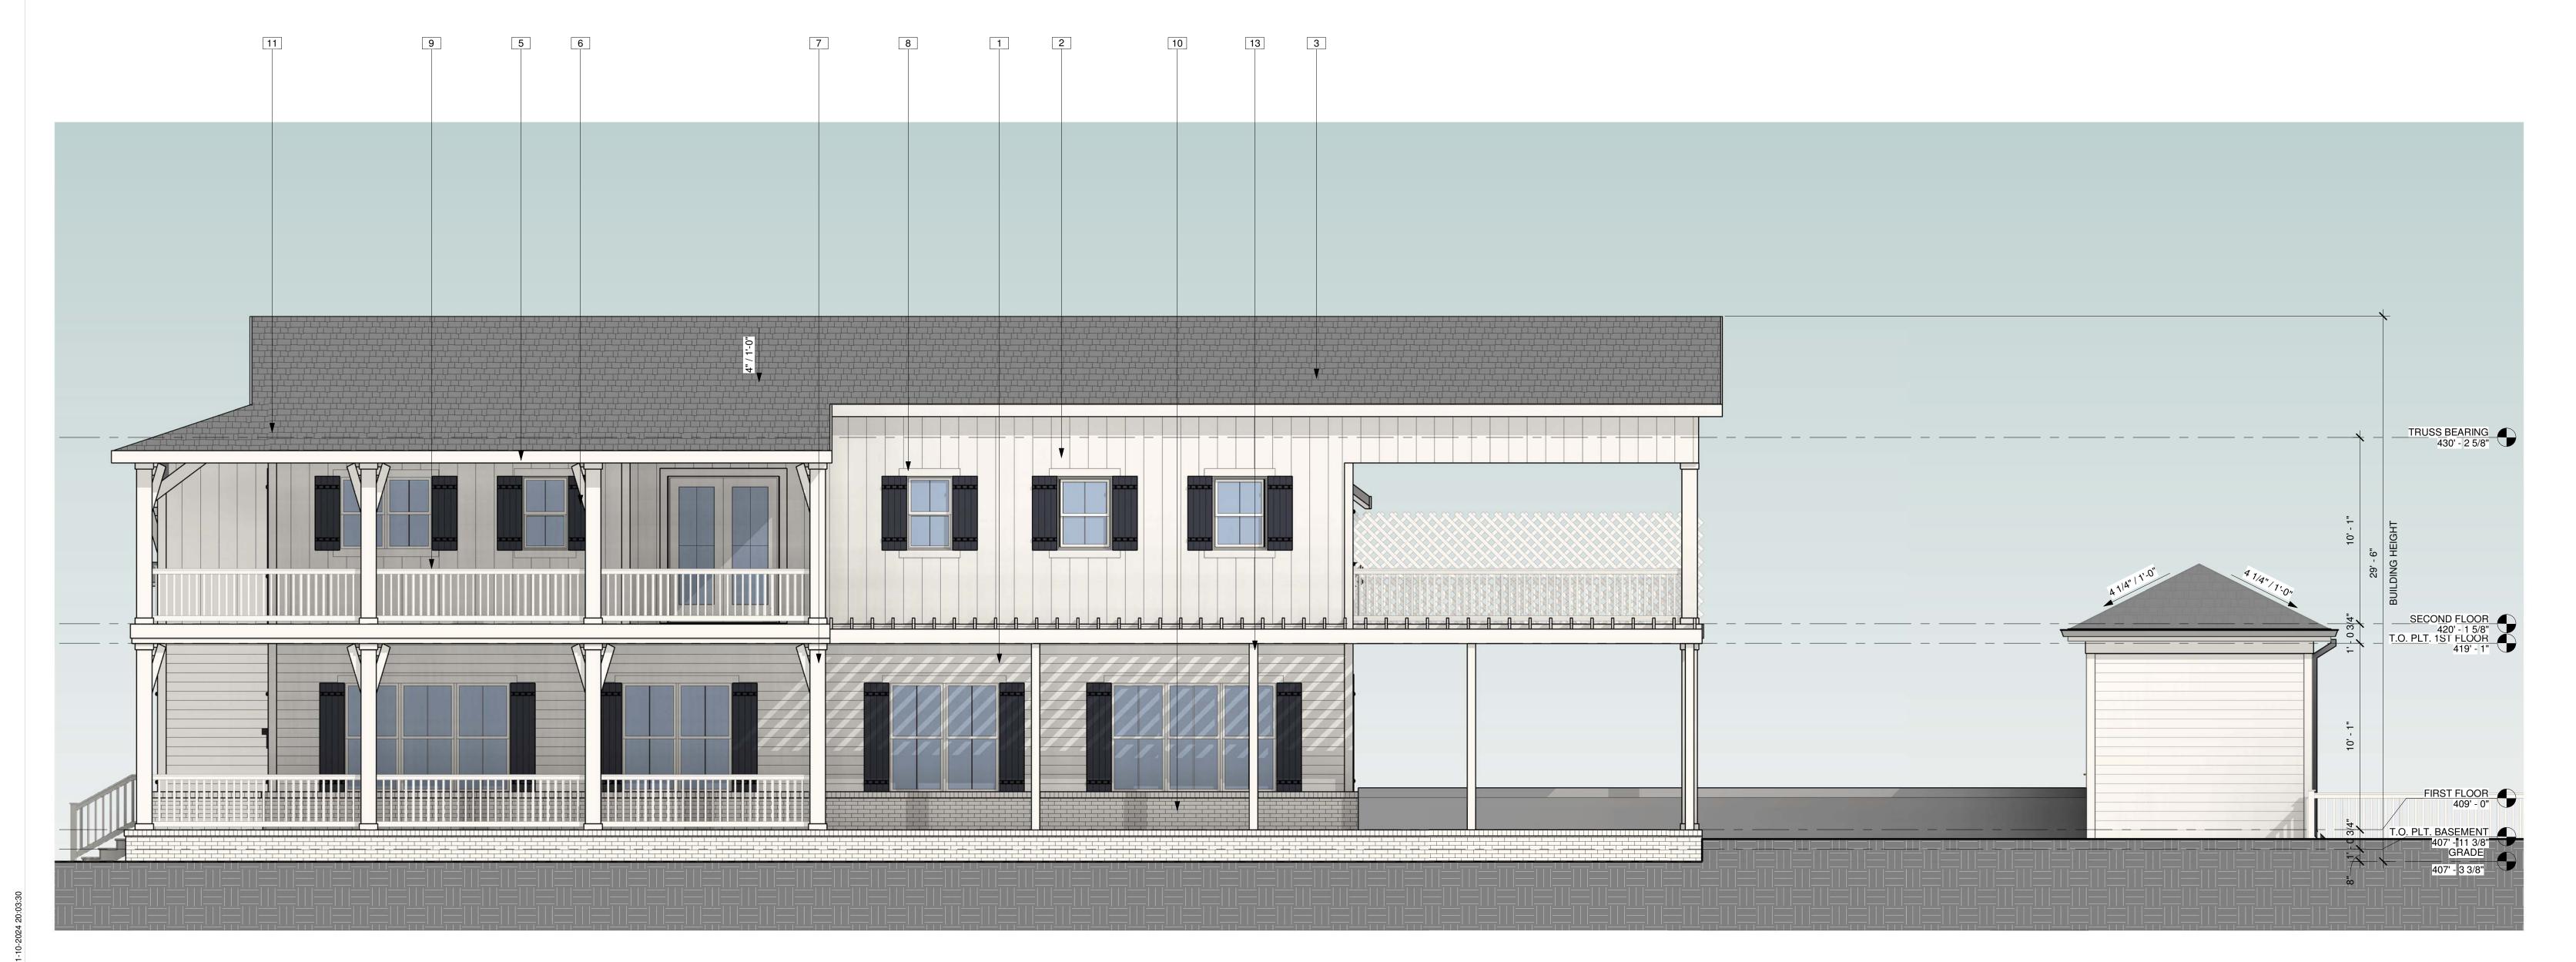

EXTERIOR ELEVATION SCHEDULE

1 HORIZONTAL SIDING VERTICAL SIDING FIBERGLASS SHINGLES ON PRE-MANUFACTURED ROOF TRUSSES 4 5/4"x8" FRIEZE 5 5/4"x8" FASCIA

6 14" BOARD AND BATTEN SHUTTERS 7 12" x 12" SQUARE COLUMN

8 4" x 4" TRIM SURROUND 9 36" HIGH WHITE VINYL RAILING

10 BRICK VENEER 11 BRACKET 12 STUCCO

14 LATTICE SCREEN 15 GUTTER

13 TRELLIS

Office: 24001 Calle De La Magdalena, unit 3896 Laguna Hills, CA 92653 Tel: (415) 316 7162 info@pixelarchltd.com www.pixelarchltd.com

PixelArch ltd.

TROWBRIDGE

Revision Notes: Description

23/09/07 Site Plan & Design Review 24/08/28 SPDR Comments

COPYRIGHT THIS DRAWING IS AN INSTRUMENT OF SERVICE AND AS SUCH, REMAINS THE PROPERTY OF PIXELARCH LTD. PERMISSION FOR USE OR REPRODUCTION IS LIMITED AND CAN BE EXTENDED ONLY BY WRITTEN PERMISSION WITH OWNER, PIXELARCH LTD.


Drawing Title:

RIGHT AND LEFT **ELEVATIONS -**MAIN HOUSE


1/4" = 1'-0"

2024.09.16


A2.2

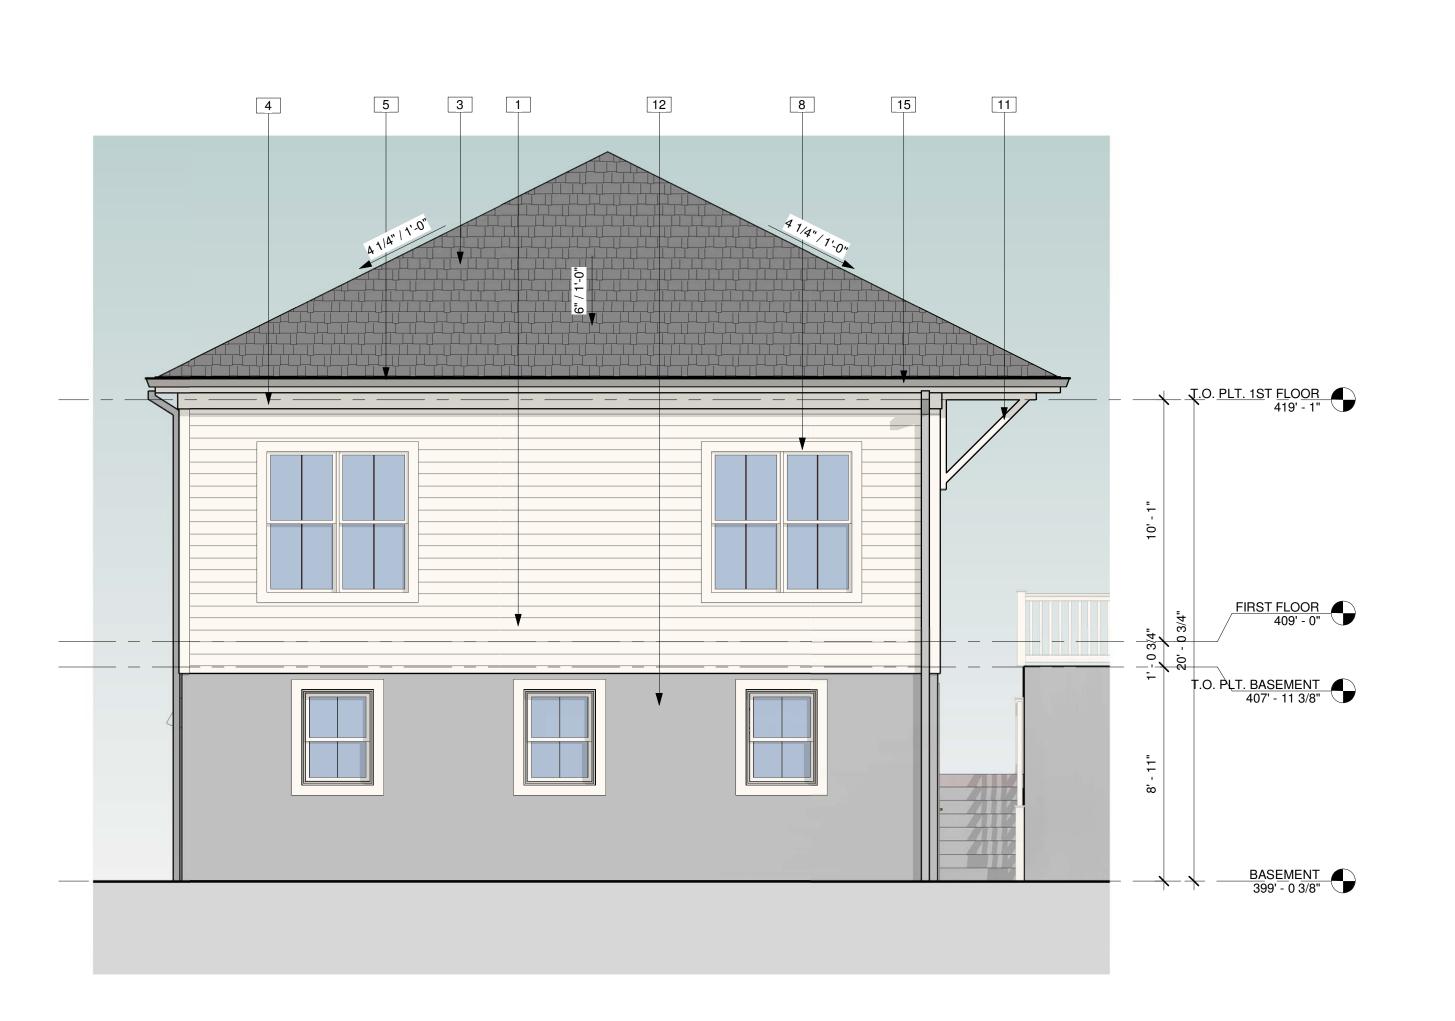


4 LEFT ELEVATION - ADU SCALE: 1/4" = 1'-0"

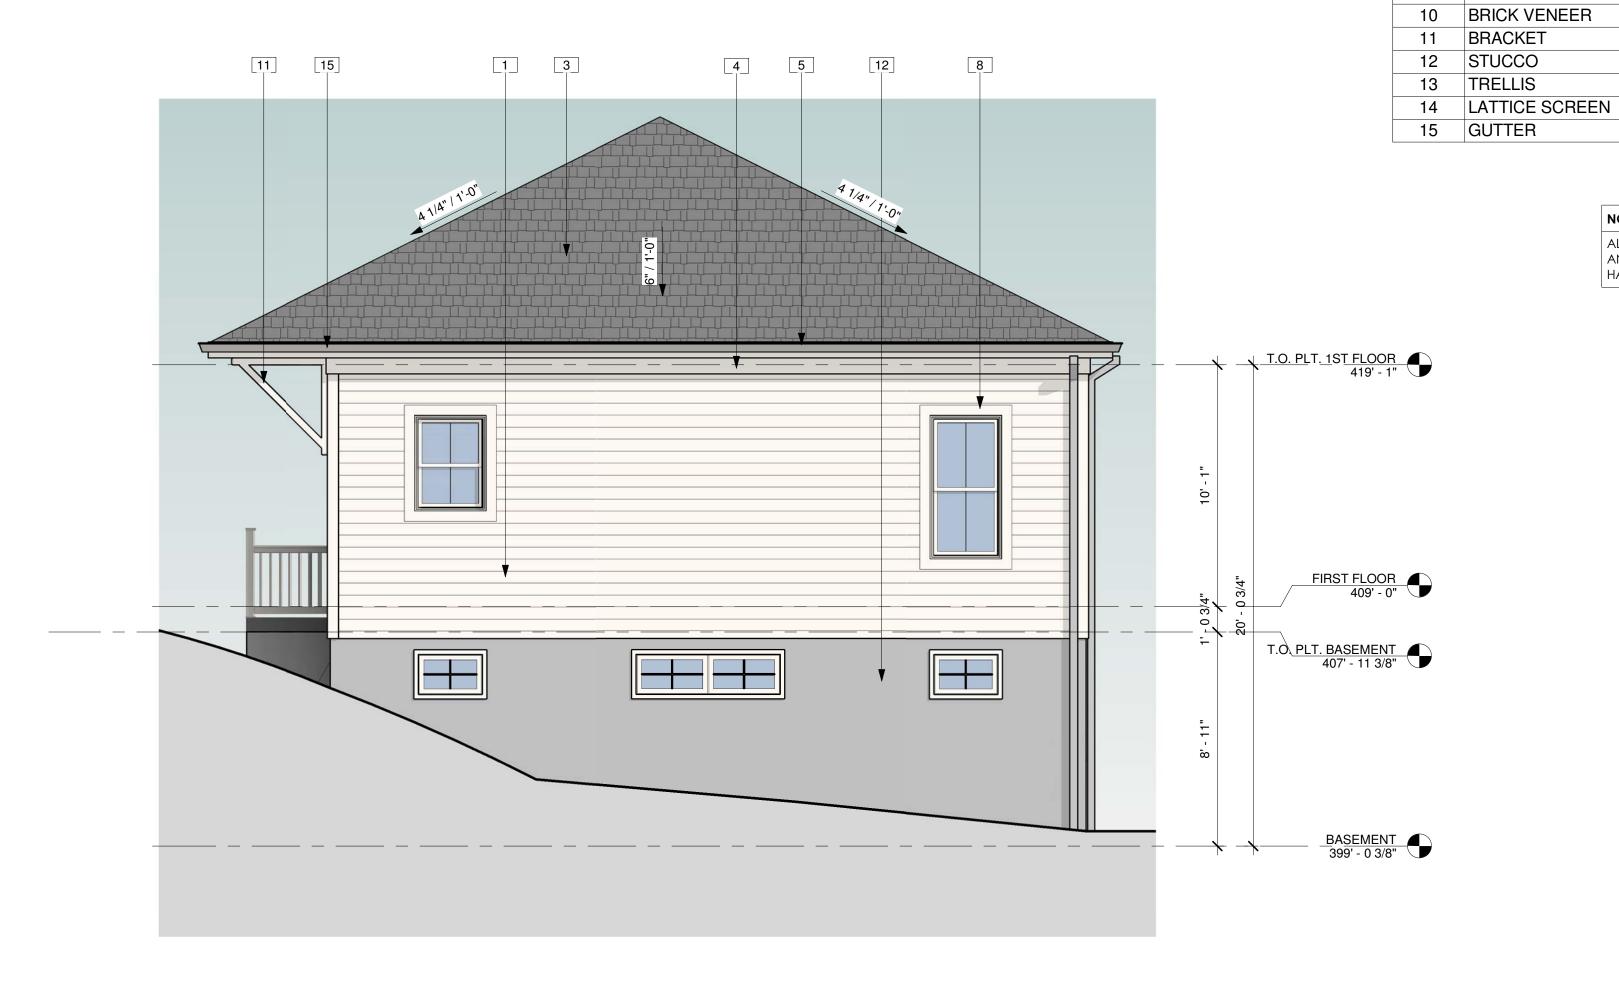

2 REAR ELEVATION - ADU SCALE: 1/4" = 1'-0"

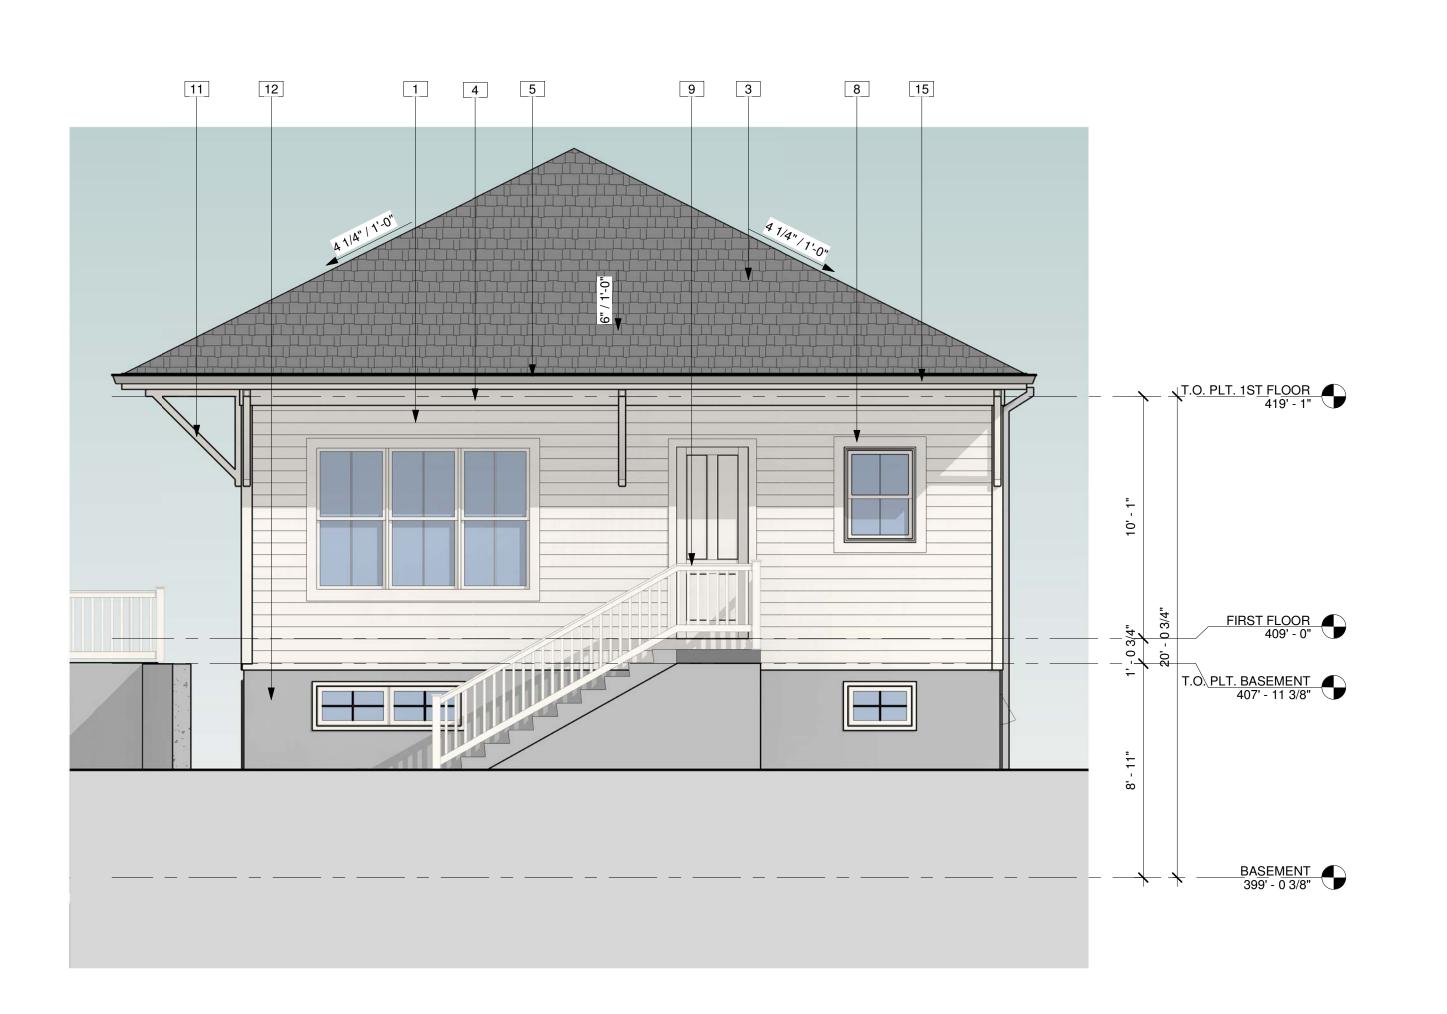

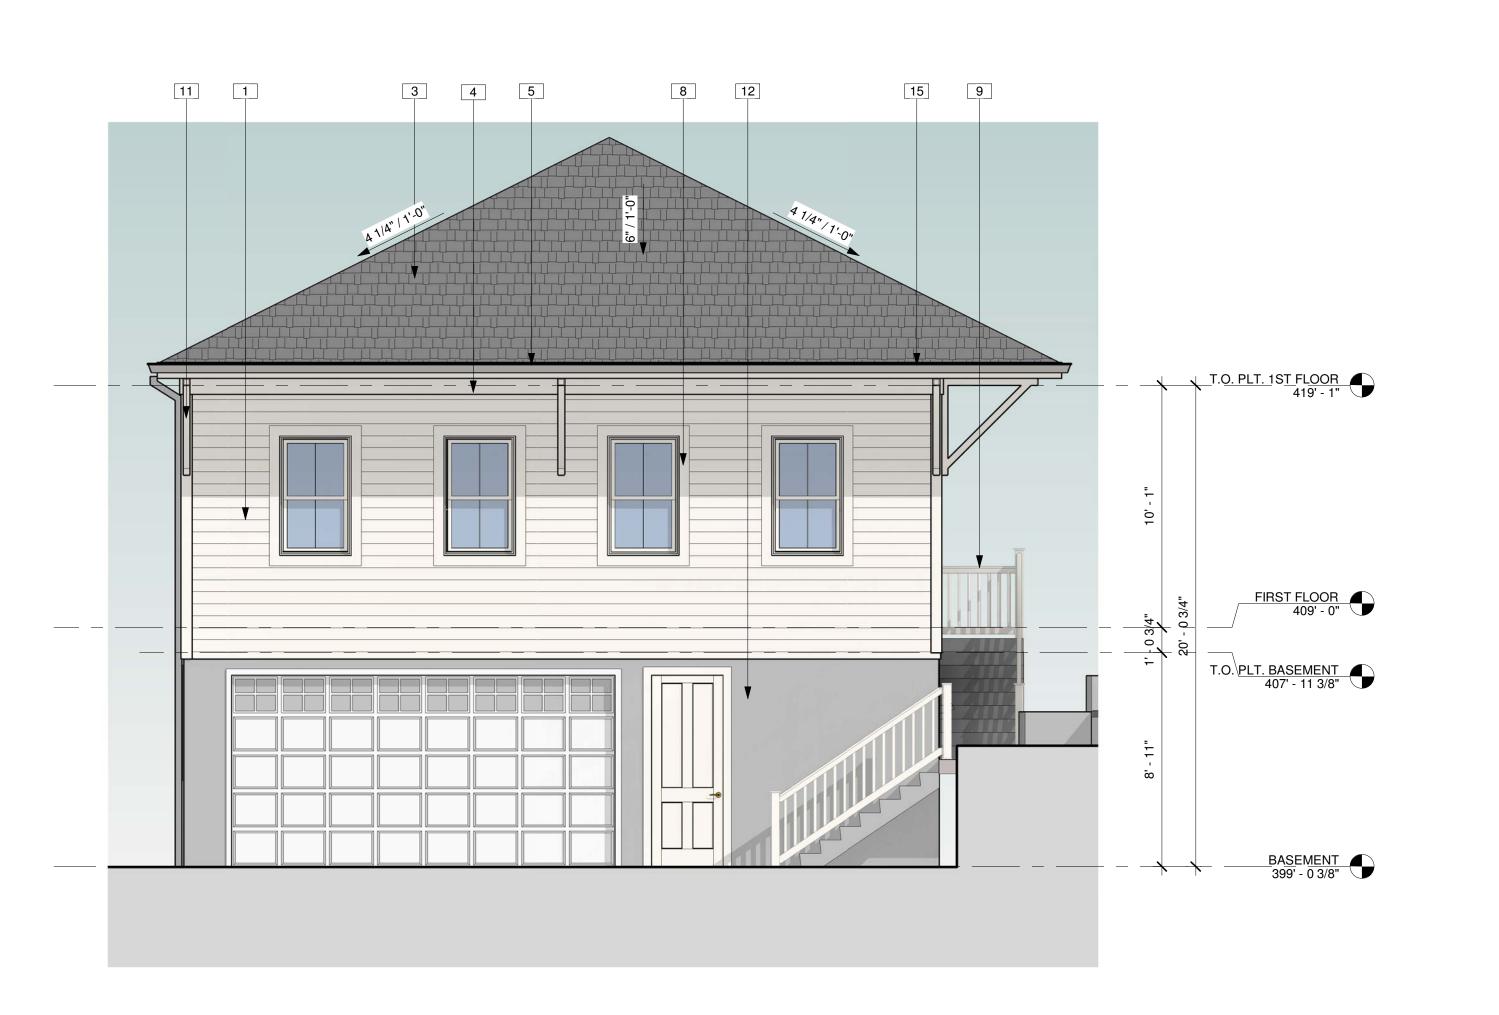

PRE-MANUFACTURED ROOF TRUSSES PixelArch ltd. Office: 24001 Calle De La Magdalena, unit 3896 Laguna Hills, CA 92653 6 14" BOARD AND BATTEN SHUTTERS Tel: (415) 316 7162 info@pixelarchltd.com www.pixelarchltd.com

> ALL WINDOWS ON ADU LEFT AND REAR ELEVATIONS TO HAVE TRANSLUCENT GLAZING

EXTERIOR ELEVATION SCHEDULE

1 HORIZONTAL SIDING 2 VERTICAL SIDING

4 5/4"x8" FRIEZE

5 5/4"x8" FASCIA

3 FIBERGLASS SHINGLES ON

7 12" x 12" SQUARE COLUMN 8 4" x 4" TRIM SURROUND

9 36" HIGH WHITE VINYL RAILING

Keynote

TROWBRIDGE 4

Revision Notes: Description 23/09/07 Site Plan & Design Review 24/08/28 SPDR Comments

COPYRIGHT THIS DRAWING IS AN INSTRUMENT OF SERVICE AND AS SUCH, REMAINS THE PROPERTY OF PIXELARCH LTD. PERMISSION FOR USE OR REPRODUCTION IS LIMITED AND CAN BE EXTENDED ONLY BY WRITTEN PERMISSION WITH OWNER, PIXELARCH LTD.

Drawing Title:

ELEVATIONS -ADU

1/4" = 1'-0"

2024.09.16

A2.3



EXTERIOR ELEVATION SCHEDULE THE COLORS AND MATERIALS
LISTED HERE ARE TO BE USED
FOR PRIMARY RESIDENCE,

ADU AND BATH HOUSE

No. Keynote 1 HORIZONTAL SIDING

2 VERTICAL SIDING 3 FIBERGLASS SHINGLES ON PRE-MANUFACTURED ROOF TRUSSES

4 5/4"x8" FRIEZE 5 5/4"x8" FASCIA 6 14" BOARD AND BATTEN SHUTTERS

7 12" x 12" SQUARE COLUMN 8 4" x 4" TRIM SURROUND

9 36" HIGH WHITE VINYL RAILING 10 BRICK VENEER

11 BRACKET 12 STUCCO

15 GUTTER

13 TRELLIS 14 LATTICE SCREEN PixelArch ltd. Office: 24001 Calle De La Magdalena, unit 3896 Laguna Hills, CA 92653 Tel: (415) 316 7162 info@pixelarchltd.com www.pixelarchltd.com

TROWBRIDGE

4

Revision Notes: Description 23/09/07 Site Plan & Design Review

24/08/28 SPDR Comments

COPYRIGHT THIS DRAWING IS AN

OF PIXELARCH LTD. PERMISSION LIMITED AND CAN BE EXTENDED WITH OWNER, PIXELARCH LTD.

Drawing Title:

MATERIAL BOARD


1/4" = 1'-0"

2024.09.16


A2.5


FRONT ELEVATION - MAIN HOUSE


SCALE: 1/4" = 1'-0"

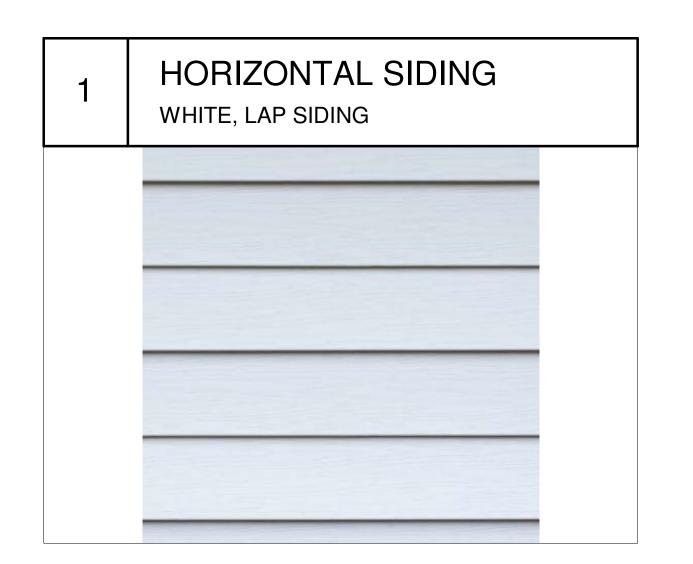




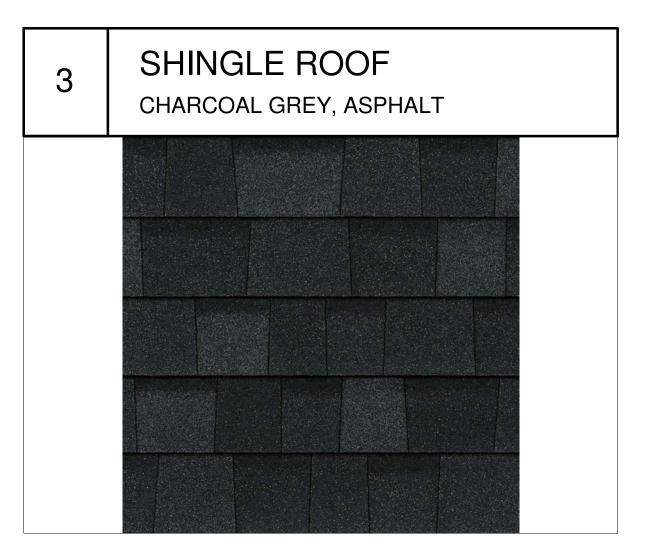


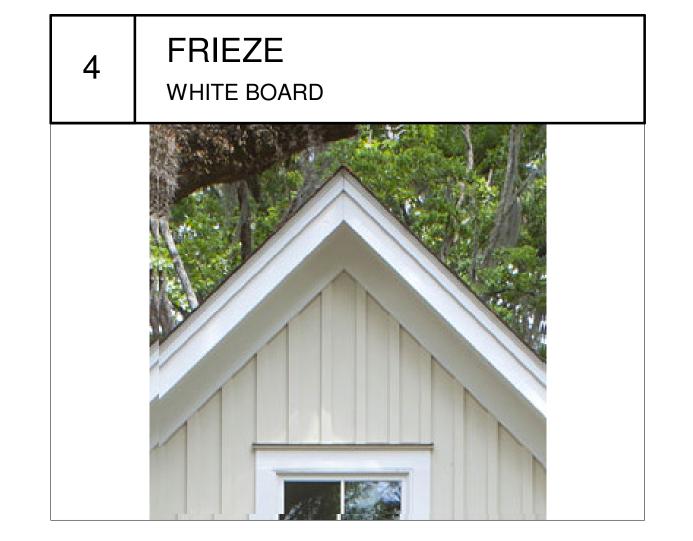

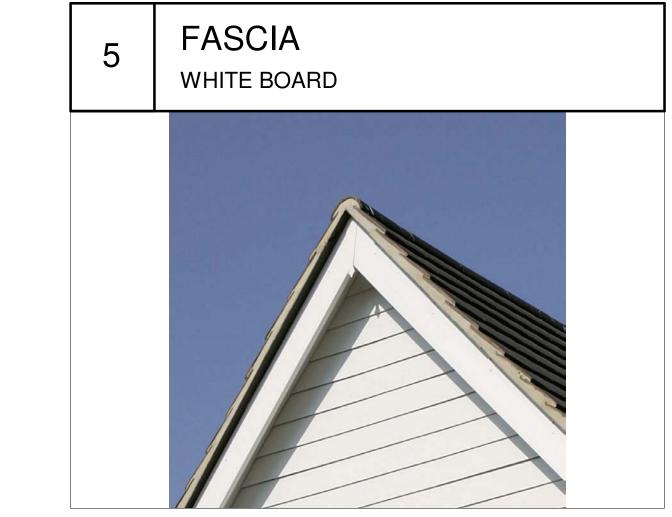

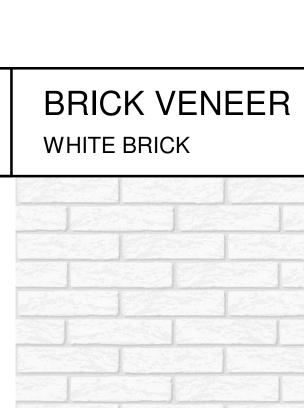




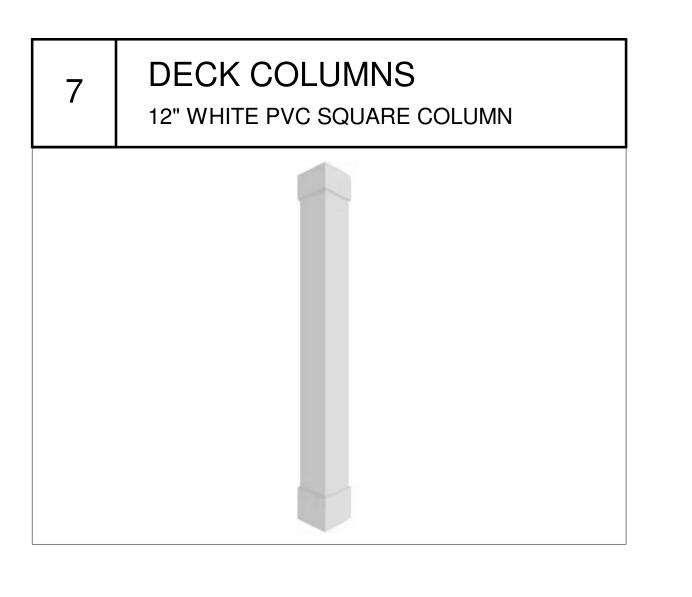





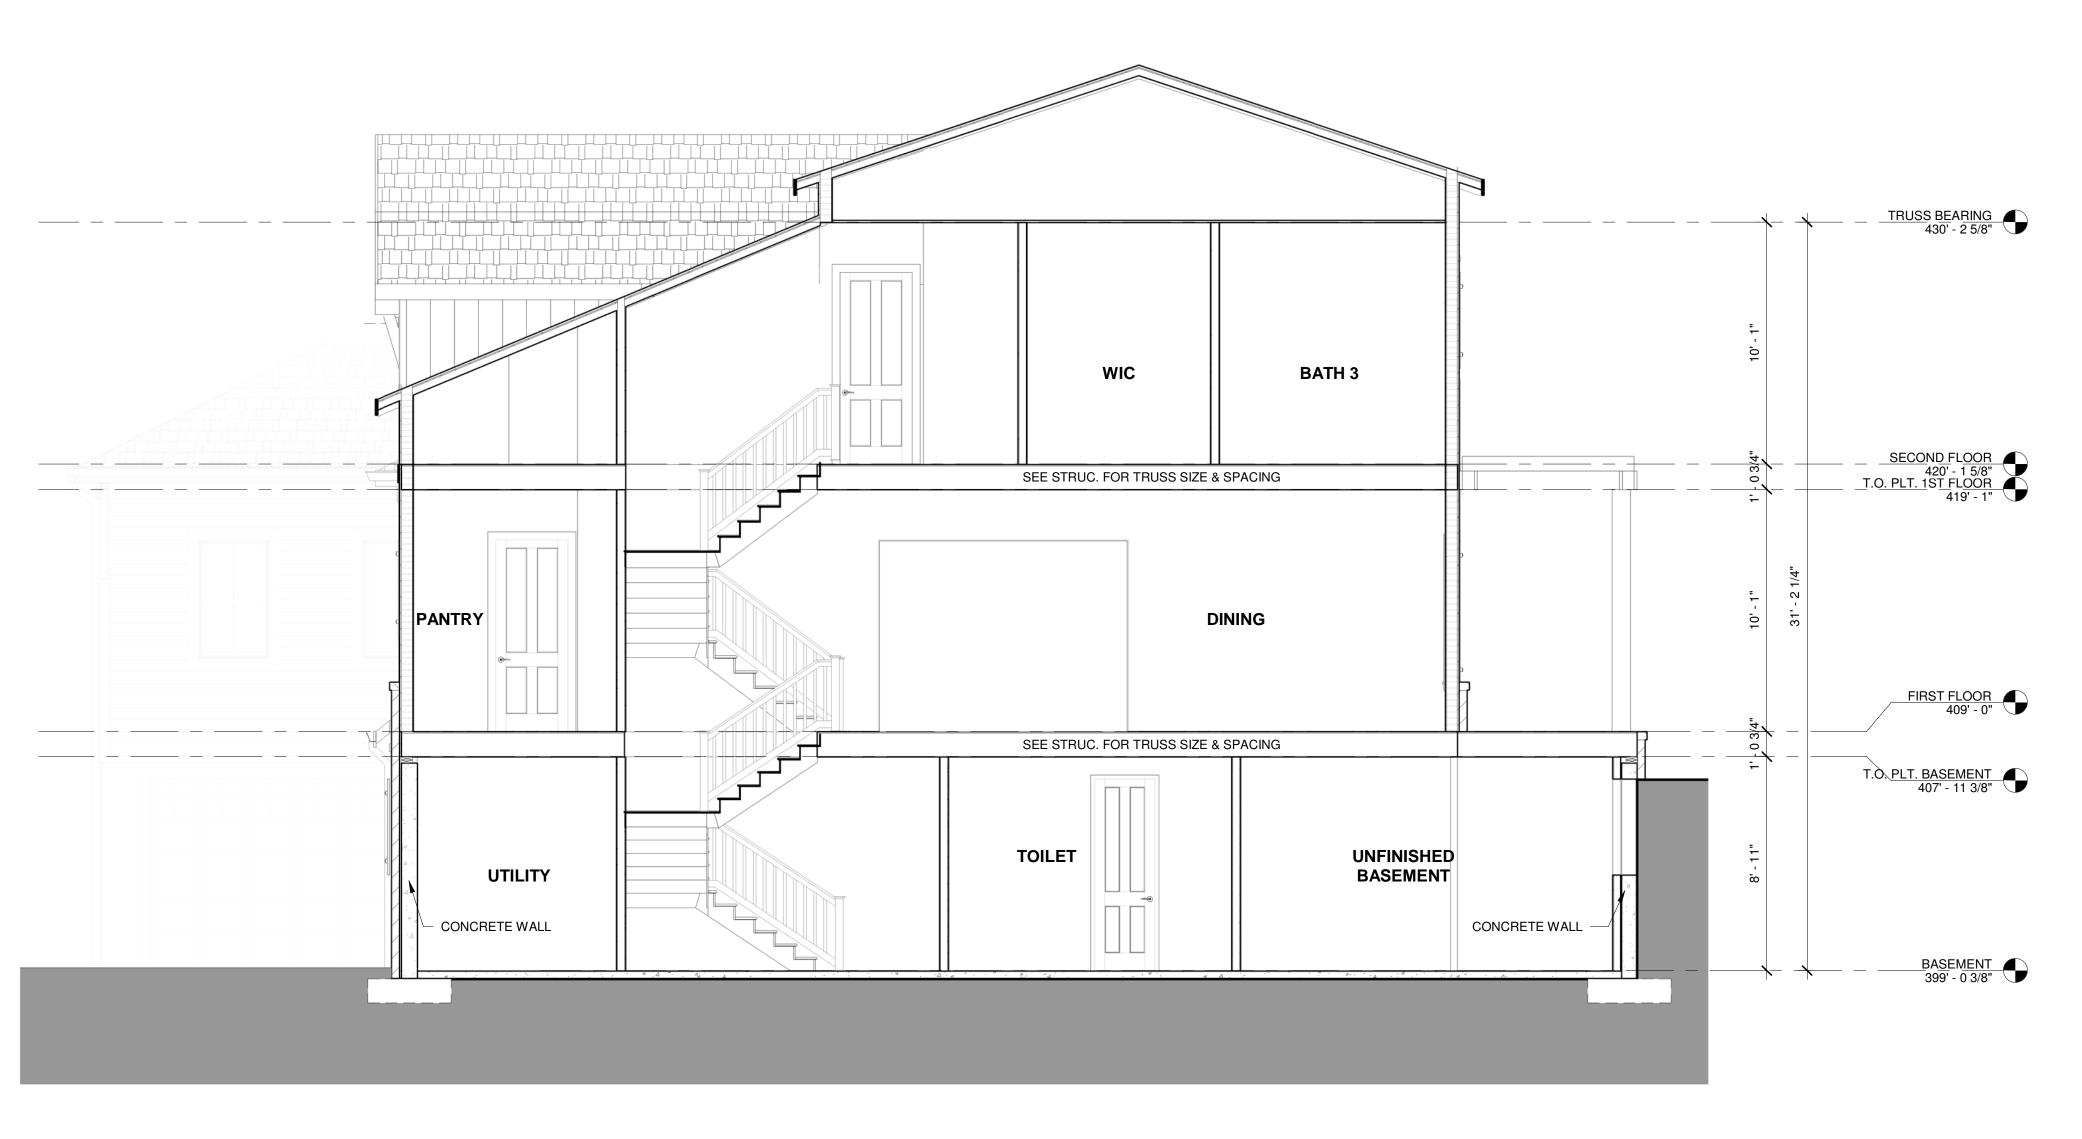

SECTION 2 - MAIN HOUSE SCALE: 1/4" = 1'-0"



PixelArch Itd.

Office:
24001 Calle De La Magdalena, unit 3896
Laguna Hills, CA 92653

Tel: (415) 316 7162
info@pixelarchItd.com
www.pixelarchItd.com

477 TROWBRIDGE LN. FOLSOM, CA 95630

Revision Notes:

Date Description
23/09/07 Site Plan & Design Review
24/08/28 SPDR Comments

COPYRIGHT
THIS DRAWING IS AN
INSTRUMENT OF SERVICE AND AS
SUCH, REMAINS THE PROPERTY
OF PIXELARCH LTD. PERMISSION
FOR USE OR REPRODUCTION IS
LIMITED AND CAN BE EXTENDED
ONLY BY WRITTEN PERMISSION
WITH OWNER, PIXELARCH LTD.


Drawing Title:

SECTIONS -MAIN HOUSE

Scale: 1/4" = 1'-0"

2024.09.16

Page No:

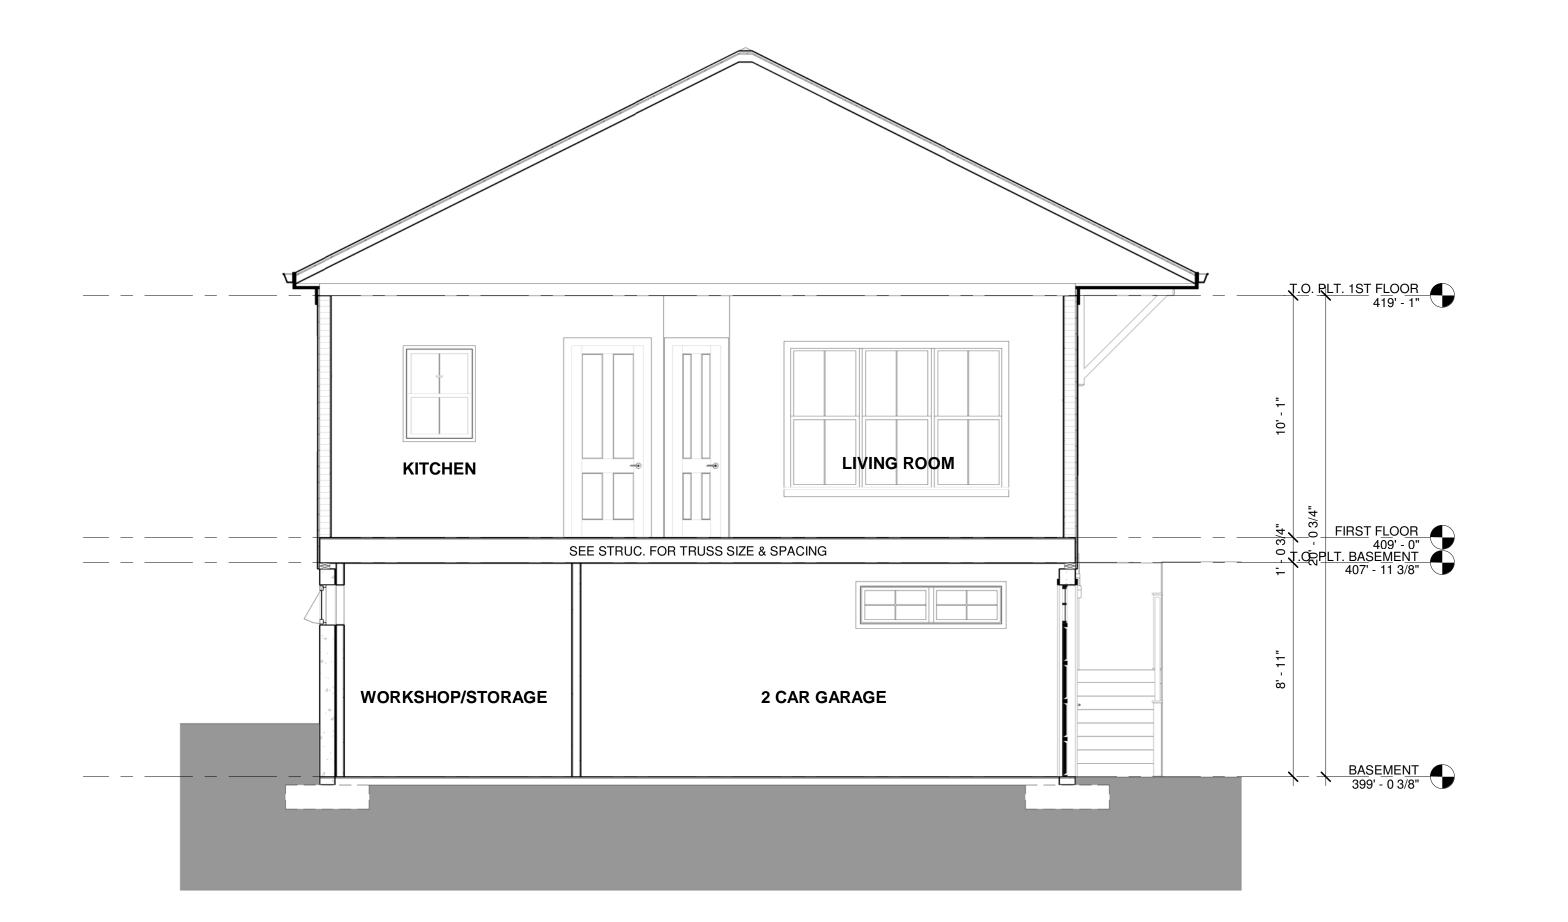

BEDROOM 2 WIC LIVING ROOM

SEE STRUC. FOR TRUSS SIZE & SPACING

2 CAR GARAGE

PIRST FLOOR

TO, PLT. 1ST FLOOR

TO, PLT. 1ST FLOOR

TO, PLT. 1ST FLOOR

TO, PLT. 1ST FLOOR

SEE STRUC. FOR TRUSS SIZE & SPACING

2 CAR GARAGE

PROVIDED TO THE PASSIVENT SIZE A SPACING

PROVIDED TO THE PASSIVENT SIZE A SPACING SIZE A SPACING SIZE AS SPACING SI

SECTION 2 - ADUSCALE: 1/4" = 1'-0"

SECTION 1 - ADUSCALE: 1/4" = 1'-0"

PixelArch Itd.

Office:
24001 Calle De La Magdalena, unit 3896
Laguna Hills, CA 92653

Tel: (415) 316 7162
info@pixelarchItd.com
www.pixelarchItd.com

477 TROWBRIDGE LN FOLSOM, CA 95630

Revision Notes:

Date Description
23/09/07 Site Plan & Design Review
24/08/28 SPDR Comments

24/08/28 SPDR Comments

COPYRIGHT
THIS DRAWING IS AN
INSTRUMENT OF SERVICE AND AS
SUCH, REMAINS THE PROPERTY
OF PIXELARCH LTD. PERMISSION
FOR USE OR REPRODUCTION IS
LIMITED AND CAN BE EXTENDED
ONLY BY WRITTEN PERMISSION
WITH OWNER, PIXELARCH LTD.

Drawing Title:

SECTIONS - ADU

Scale:

Date: 2024.09.16

1/4" = 1'-0"

Dama Na

A3.2

TROWBRIDGE LN

477 TROWBRIDGE LN, FOLSOM, SACRAMENTO, CA 95630

PROJECT INFORMATION

ASSESSOR PARCEL# **ADDRESS** POSTAL CITY, ZIP JURISDICTION ASSESSOR'S MAP ASSESSOR LAND USE CODE ASSESSOR'S PROPERTY DESCRIPTION

APPROX. PARCEL AREA

ZONING:

PROPOSED RCFE BUILDING:

OCCUPANCY GROUP & BUILDING USE: TYPE OF CONSTRUCTION: STORIES:

TOTAL PROPOSED BUILDING AREA:

PROPOSED ADU:

OCCUPANCY GROUP & BUILDING USE: TYPE OF CONSTRUCTION:

STORIES: TOTAL PROPOSED BUILDING AREA:

07109000450000 477 TROWBRIDGE LN FOLSOM 95630 CITY OF FOLSOM BK.071, PG.090

POR OF LOTS 25 & 26 IN WILLOW CREEK ESTATES SOUTH UNIT NO 8,

BEG AT MOST S'LY COR OF SD LOT 25 19298 SQ FT / 0.44 ACRES

R-1-ML (PD) - SINGLE FAMILY RESIDENTIAL - MEDIUM LOT/PLANNED DEVELOPMENT

R-2.1 (RCFE)

V-A (AUTOMATIC SPRINKLERS)

6,241 SF

BUILDING CODE STANDARDS:

2022 PART 1 CALIFORNIA ADMINISTRATIVE CODE (CAC) 2022 PART 2 CALIFORNIA BUILDING CODE (CBC) 2022 PAET 2.5 CALIFORNIA RESIDENTIAL CODE (CRC) 2022 PART 3 CALIFORNIA ELECTRICAL CODE (CEC) 2022 PART 4 CALIFORNIA MECHANICAL CODE (CMC) 2022 PART 5 CALIFORNIA PLUMBING CODE (CPC) 2022 PART 6 CALIFORNIA ENERGY CODE (CEC)

2022 PART 8 CALIFORNIA HISTORICAL BUILDING CODE (CHBC)

2022 PART 9 CALIFORNIA FIRE CODE (CFC)

2022 PART 10 CALIFORNIA EXISTING BUILDING CODE (CEBC) 2022 PART 11 CALIFORNIA GREEN BUILDING STANDARDS CODE (CGBSC)

2022 PART 12 CALIFORNIA REFERENCED STANDARD CODE

CALIFORNIA UNIFORM RETAIL FOOD FACILITIES LAW CITY OF BAKERSFIELD MUNICIPAL CODE KERN COUNTY CODE OF ORDINANCES

KERN COUNTY CONSTRUCTION GUIDELINES FOR FOOD **FACILITIES**

* SOME CODES MAY NOT APPLY IF WORK REGULATED BY SUCH CODES IS NOT WITHIN THE SCOPE OF THIS PROJECT.

 THE CONTRACTOR SHALL BE RESPONSIBLE FOR APPLYING AND OBTAINING ALL REQUIRED PERMIT AND INSPECTIONS TO CONFORM WITH BUILDING AND FIRE CODES.

SHEET LIST

GENERAL NOTES EXISTING CONDITIONS

FLOOD MAP

EROSION & SEDIMENTATION CONTROL

STANDARD DETAILS FOR CONSTRUCTION BMPs

DRAINAGE PLAN

C7 STORM WATER MANAGEMENT PLAN

GRADING PLAN PAVING PLAN


WATER LINE PLAN

WATER & IRRIGATION STANDARD DETAILS

WASTE WATER LINE

WASTE WATER STANDARD DETAILS

SITE PLAN

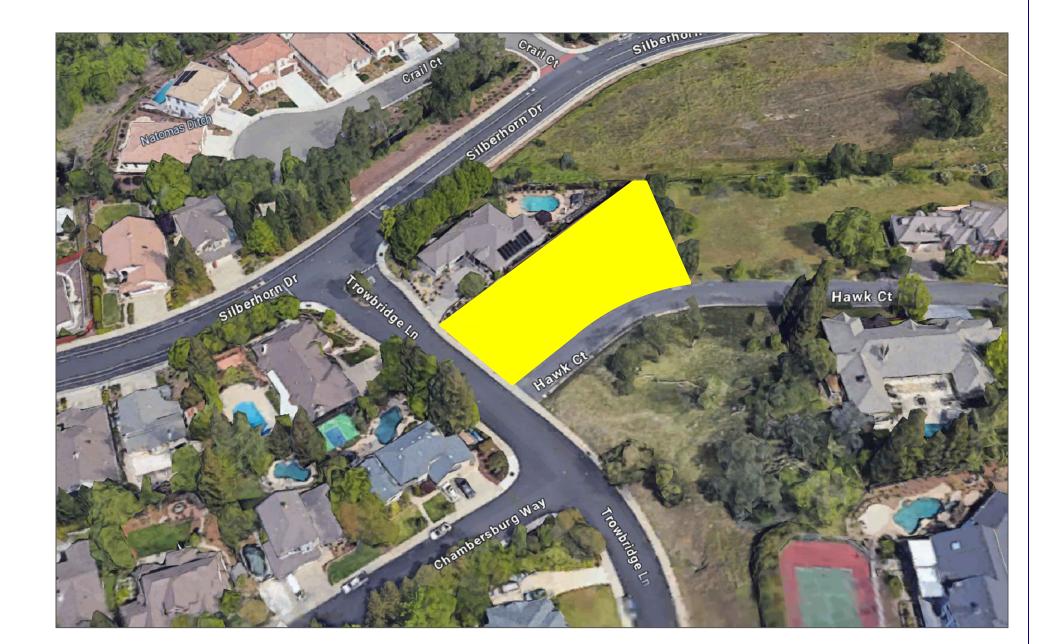



24001 Calle De La Magdalena, unit 3896 Laguna Hills, CA 92653 Tel: (415) 316 7162 info@pixelarchltd.com www.pixelarchltd.com




Description Date

COPYRIGHT THIS DRAWING IS AN INSTRUMENT OF SERVICE AND AS SUCH, PIXELARCH LTD. PERMISSION FOR WITH OWNER, PIXELARCH LTD

DRAWING TITLE:

COVER SHEET

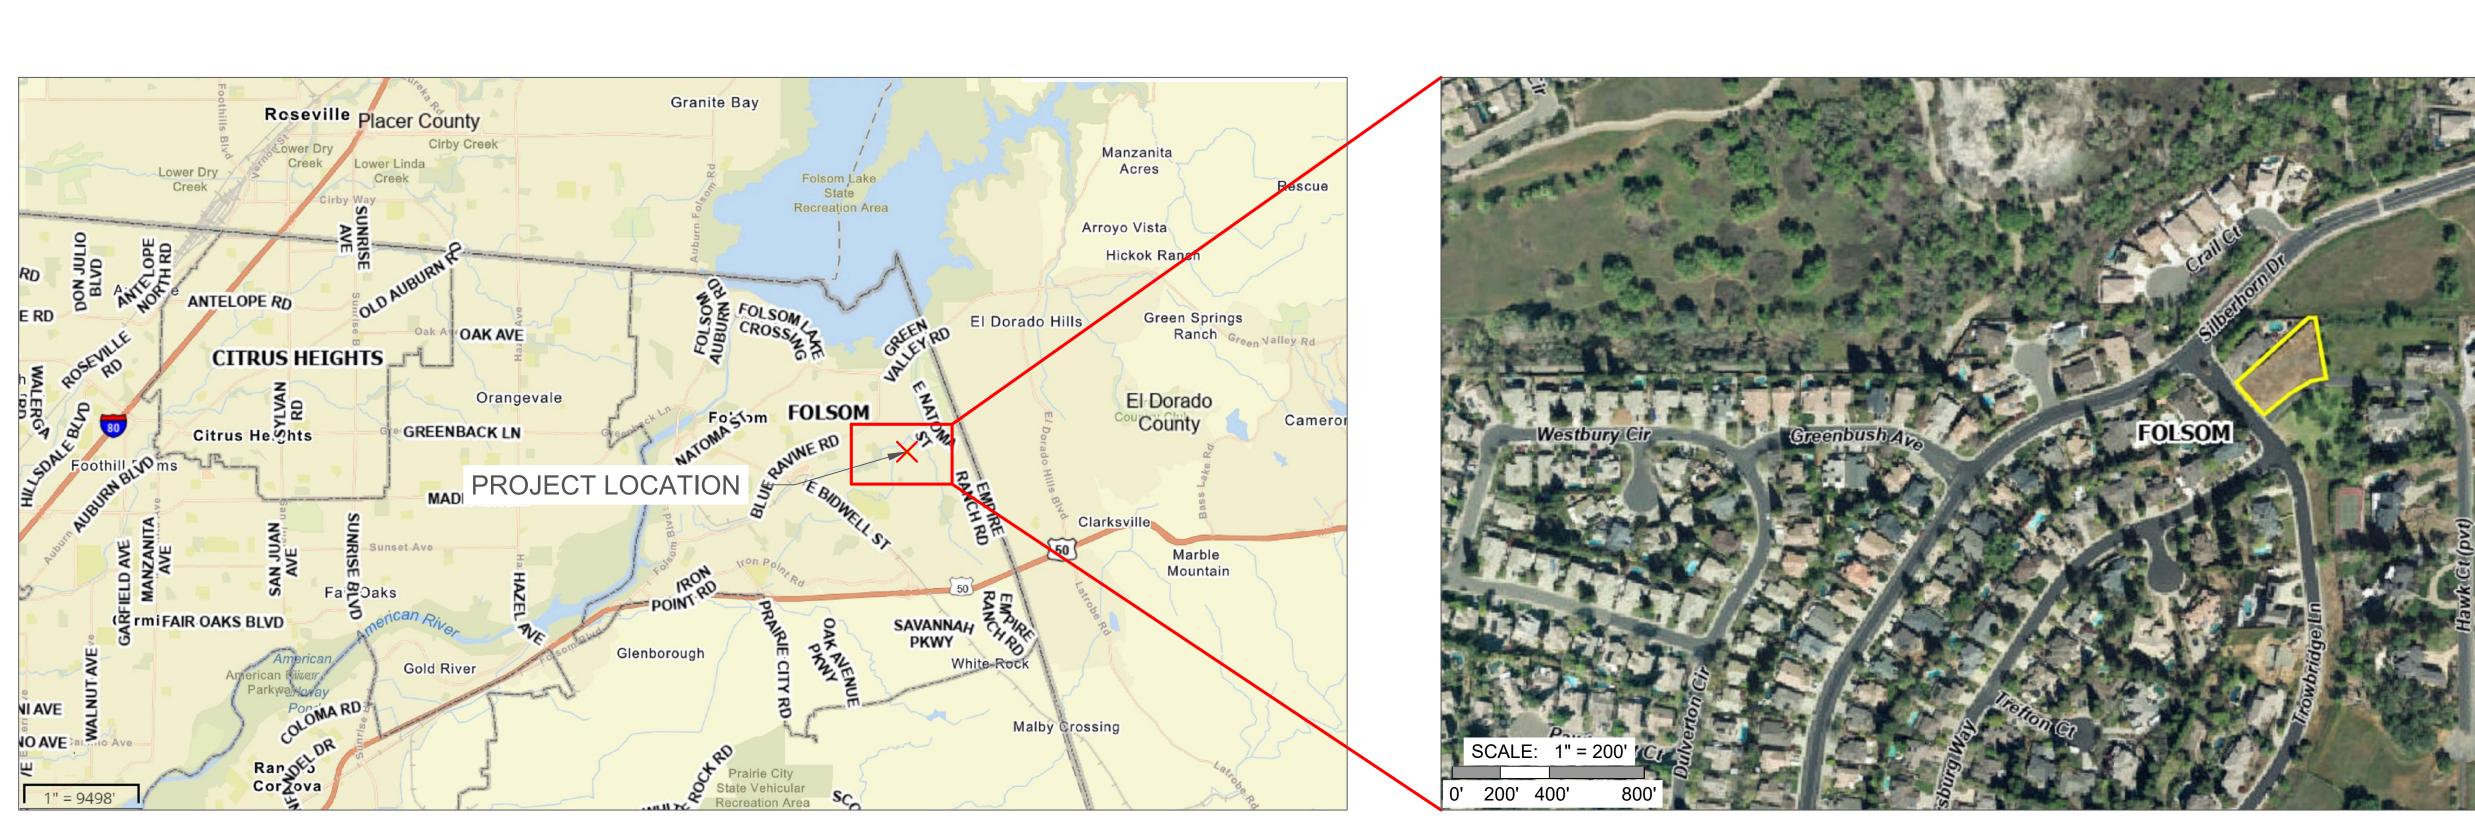

GENERAL NOTES:

- ALL MATERIALS AND CONSTRUCT ION PROCEDURES WITHIN THE SCOPE OF THIS CONTRACT SHALL COMPLY WITH: A. CURRENT CITY OF FOLSOM CA CONSTRUCTION SPECIFICATIONS AND STANDARDS AS OF THE DATE OF
- B. THE MOST CURRENT EDITION OF THE STATE OF CALIFORNIA DEPARTMENT OF TRANSPORTATION (CADOT)
- STANDARD SPECIFICATIONS. C. THE ADOPTED EDITION OF THE STATE OF CALIFORNIA BUILDING CODES ALONG WITH THE SPECIFIC CODE MODIFICATIONS ADOPTED BY THE SACRAMENTO COUNTY.
- CONTRACTOR SHALL PROCURE ALL PERMITS AND LICENSES, PAY ALL CHARGES, FEES, AND TAXES AND GIVE ALL
- NOTICES NECESSARY AND INCIDENTAL TO THE DUE AND LAWFUL PROSECUTION OF THE WORK 3. ANY EXISTING OFF-SITE IMPROVEMENTS THAT ARE DAMAGED OR UNDERCUT BY THE CONTRACTOR'S
- OPERATIONS SHALL BE REPAIRED OR REPLACED AS DIRECTED BY THE ENGINEER AND APPROVED BY THE OWNER OF THE EXISTING IMPROVEMENT AT THE CONTRACTOR'S EXPENSE (NO SEPARATE PAY ITEM).
- WORK COMPLETED BY THE CONTRACTOR WHICH HAS NOT RECEIVED A WORK ORDER OR CONSENT OF THE OWNER OR ENGINEER WILL BE SUBJECT TO REMOVAL AND REPLACEMENT BY AND AT THE EXPENSE OF THE CONTRACTOR
- CONTRACTOR IS RESPONSIBLE FOR REMOVAL OF ALL WASTE MATERIALS UPON PROJECT COMPLETION. THE CONTRACTOR SHALL NOT PLACE ANY WASTE MATERIAL IN ANY 100-YEAR FLOOD PLAIN WITHOUT FIRST OBTAINING AN APPROVED FLOOD PLAIN DEVELOPMENT PERMIT.
- 6. BARRICADES AND WARNING SIGNS SHALL CONFORM TO THE CADOT MANUAL ON UNIFORM TRAFFIC CONTROL DEVICES (TMUTCD) AND SHALL BE LOCATED TO PROVIDE MAXIMUM PROTECTION TO THE PUBLIC AS WELL AS CONSTRUCTION PERSONNEL AND EQUIPMENT WHILE PROVIDING CONTINUOUS TRAFFIC FLOW AT ALL TIMES DURING CONSTRUCTION. THE CONTRACTOR IS RESPONSIBLE FOR MAINTAINING ALL DEVICES DURING CONSTRUCTION.
- CONTRACTOR IS REQUIRED TO VERIFY PROJECT ELEVATIONS. THE TERM "MATCH EXISTING" SHALL BE UNDERSTOOD TO SIGNIFY BOTH HORIZONTAL AND VERTICAL ALIGNMENT
- WHEN MATCHING EXISTING PAVEMENTS. CURBS, DRIVES, AND WALKS, THEY SHALL BE SAW CUT FULL DEPTH AND REMOVED TO ALLOW FOR PROPOSED CONSTRUCTION. IF ANY EXISTING JOINT IS ENCOUNTERED, PRECAUTION SHALL BE TAKEN DURING REMOVAL OF CONCRETE SO AS NOT TO DAMAGE EXISTING DOWELS. ALL EXISTING DOWELS SHALL BE EXPOSED AND CLEANED.
- 9. ALL "COMPACTED SUBGRADE" SHALL CONSIST OF NATIVE MATERIAL SCARIFIED TO A MINIMUM DEB OF SIX INCHES
- AND COMPACTED TO 95% DENSITY ACCORDING TO ASTM D-698 AND TESTED BY ASTM D-2922. 10. ALL "FLEXIBLE BASE" SHALL BE TYPE "A", GRADE 1, COMPACTED TO 100% MODIFIED DENSITY AT A MOISTURE CONTENT BETWEEN -2 AND +3 OF OPTIMUM PERCENT MOISTURE ACCORDING TO ASTM D-1557 (MODIFIED
- PROCTOR) AND TESTED BY ASTM D-2922. 11. ASPHALT PAVEMENT SHALL BE THE TYPE SPECIFIED ON THE PLANS AND ACCORDING TO TXDOT "HOT MIX
- ASPHALT CONCRETE PAVEMENT". 12. PRIME COAT USING MC-30 AT A RATE OF 0.2 GALLONS PER SQUARE YARD SHALL BE PLACED OVER PREPARED BASE AT LEAST ONE DAY PRIOR TO LAYING ASPHALTIC CONCRETE PAVEMENT. ANY NECESSARY TACK COAT SHALL BE MC-30 AT 0.05 GALLONS PER SQUARE YARD.
- 13. CONCRETE SHALL BE CLASS "A" UNLESS OTHERWISE ON PLANS.
- 14. REINFORCING STEEL SHALL BE FROM NEW BILLET. ALL DIMENSIONS RELATING TO REINFORCING STEEL ARE TO CENTER OF BARS EXCEPT WHEN REFERRING TO CLEARANCE
- 15. ALL SAWED JOINTS SHALL BE SAWED WITHIN 24 HOURS OF POURING.
- ORDINARY COMPACTION CONTROL IS REQUIRED ON THIS PROJECT.
- 17. ALL ROLLING FOR COMPACTION OF ASPHALTIC CONCRETE PAVEMENT SHALL BE COMPLETED BEFORE THE MIXTURE TEMPERATURE DROPS BELOW 175 DEG. (F).
- 18. CONTRACTOR AGREES TO ASSUME SOLE AND COMPLETE RESPONSIBILITY FOR JOB SITE CONDITIONS DURING THE CONSTRUCTION OF THE PROJECT, INCLUDING SAFETY OF ALL PERSONS AND PROPERTY; THAT THIS REQUIREMENT SHALL APPLY CONTINUOUSLY AND SHALL NOT BE LIMITED TO THE NORMAL WORKING HOURS; AND THAT THE CONTRACTOR SHALL DEFEND, INDEMNIFY AND HOLD THE OWNERS AND THE ENGINEER AND HIS EMPLOYEES, PARTNERS, OFFICES, DIRECTORS, OR CONSULTANTS, HARMLESS FROM ANY AND ALL LIABILITY. REAL OR ALLEGED, IN CONNECTION WITH THE PERFORMANCE OF THE WORK ON THIS PROJECT, EXCEPTING FROM LIABILITY ARISING FROM SOLE NEGLIGENCE OF THE OWNER OR ENGINEER, ENGINEER'S DIRECTORS, OFFICERS, EMPLOYEES, OR CONSULTANTS.
- 19. ALL CMP (CORRUGATED METAL PIPE) USED ON THIS PROJECT SHALL HAVE A MANNING'S "N" VALUE OF 0.024, UNLESS OTHERWISE SHOWN ON PLANS.
- 20. ALL COST ASSOCIATED WITH THE REMOVAL, REPLACEMENT AND TESTING SHALL BE PAID BY THE CONTRACTOR.
- 21. ALL PVC SLEEVES SHALL BE INSTALLED THREE FEET (3') BELOW FINISHED GRADE AND ENDS SHALL BE MARKED SO THAT LOCATIONS OF SLEEVES CAN BE EASILY IDENTIFIED.

UTILITIES:

- LOCATION AND DEPTH OF EXISTING UTILITIES SHOWN HERE ARE APPROXIMATE ONLY. ACTUAL LOCATIONS AND DEPTHS MUST BE VERIFIED BY THE CONTRACTOR PRIOR TO CONSTRUCTION. THE CONTRACTOR SHALL BE RESPONSIBLE FOR PROTECTION OF ALL EXISTING UTILITIES ENCOUNTERED DURING CONSTRUCTION, INCLUDING THOSE NOT SHOWN ON THE DRAWINGS.
- ANY EXISTING UTILITIES, ON OR OFF THE SITE, THAT ARE DAMAGED OR UNDERCUT BY THE CONTRACTOR'S OPERATIONS SHALL BE REPAIRED OR REPLACED AS DIRECTED BY THE ENGINEER AND APPROVED BY THE RESPECTIVE UTILITY COMPANY AT THE CONTRACTOR'S EXPENSE.
- DUE TO FEDERAL REGULATIONS TITLE 49, PART 192(8), GAS COMPANIES MUST MAINTAIN ACCESS TO GAS VALVES AT ALL TIMES. THE CONTRACTOR MUST PROTECT THE WORK AROUND ANY GAS VALVES THAT ARE IN THE PROJECT AREA. CONTRACTOR SHALL REFERENCE CITY UTILITIES PLANS FOR FINAL ELECTRICAL LINE DESIGNS AND LAYOUT.

SEWER NOTES:

- THE CONTRACTOR SHALL MAINTAIN SERVICE TO EXISTING SANITARY SEWERS AT ALL TIMES DURING CONSTRUCTION.
- 2. A MINIMUM OF SIX INCHES (6") WASTEWATER PIPE AND FITTINGS (ASTM D3034 SDR 26) ARE REQUIRED ON ALL NEW INSTALLATION.
- ALL RESIDENTIAL WASTEWATER SERVICE LATERALS SHALL BE EXTENDED TO THE PROPERTY LINE AND A CLEANOUT SHALL BE INSTALLED AT THE PROPERTY LINE. SERVICES TO LOTS WILL EXTEND THROUGH 10-FOOT (10') UTILITY EASEMENT.
- 4. SECONDARY BACKFILL OF SEWER LINES SHALL GENERALLY CONSIST OF MATERIALS REMOVED FROM THE TRENCH AND SHALL BE FREE FROM BRUSH, DEBRIS, AND TRASH, NO ROCKS OR STONES HAVING ANY DIMENSION LARGER THAN FOUR INCHES (4") AT THE LARGEST DIMENSION.
- 5. ALL SEWER PIPES SHALL HAVE COMPRESSION OR MECHANICAL JOINTS.
- ALL MANHOLES SHALL BE CONSTRUCTED OF FOUR FOOT DIAMETIER (4' Ø) REINFORCED CONCRETE PIPE MEETING THE REQUIREMENTS OF ASTM SPECIFICATIONS C-478 OR POUR MONOLITHICALLY. CONCRETE RINGS SHALL BE USED TO ADJUST MANHOLE HEIGHTS TO MATCH EXISTING GRADE, MAXIMUM HEIGHT SHALL NOT EXCEED TWELVE INCHES (12"). CAST IRON FRAMES AND COVERS SHALL CONFORM TO ASTM SPECIFICATIONS A-4B CLASS 30.
- 7. MANHOLE RINGS AND COVERS SHALL WEIGH A MINIMUM OF 460 POUNDS. OUTSIDE DIAMETER OF THE LID SHALL BE THIRTY-TWO INCHES (32"). MANHOLES SHALL BE CONSTRUCTED OF OR LINED WITH A CORROSION MATERIAL RESISTANT MATERIAL. WHERE NEW CONSTRUCTION TIES INTO AN EXISTING MANHOLE, THE EXISTING MANHOLE MUST BE LINED, COATED, OR REPLACED WITH A CORROSION RESISTANT MATERIAL
- 8. LIDS ARE TO BE SOLID WITH NO PICK HOLES.
- 9. MANHOLE COVERS SHALL BE MARKED "SANITARY SEWER". PIPE CONNECTIONS TO MANHOLES SHALL BE CORED AND WATER TIGHT MANHOLE CONNECTORS KOR-N-SEAL I & II OR EQUAL ASTM C.
- 10. ALL MANHOLES SHALL BE CONSTRUCTED SO THAT THE TOP OF THE RING IS 2" ABOVE THE SURROUNDING GROUND EXCEPT WHEN LOCATED IN PAVED AREAS. IN PAVED AREAS, THE MANHOLE RING SHALL BE FLUSH WITH
- 11. WASTEWATER PIPE CONNECTIONS TO MANHOLES SHALL BE MADE WATER TIGHT USING A GASKET AROUND THE PIPE. THE GASKET PIPE SHALL THEN BE GROUTED INTO PLACE, USING A STIFF MIX NON-SHRINK GROUT, VIA

- KNOCKED OUT HOLES IN CONCRETE PIPE WALLS. STEPS SHALL NOT BE PROVIDED.
- 12. WASTEWATER LINES SHALL BE TESTED FROM MANHOLE TO MANHOLE.
- 13. IN AREAS WHERE A NEW WASTEWATER MANHOLE IS TO BE CONSTRUCTED OVER AN EXISTING WASTEWATER SYSTEM, IT SHALL BE THE CONTRACTORS RESPONSIBILITY TO TEST THE EXISTING MANHOLES BEFORE CONSTRUCTION. AFTER PROPOSED MANHOLE HAS BEEN BUILT, THE CONTRACTOR SHALL RE-TEST THE EXISTING SYSTEM TO THE SATISFACTION OF THE CONSTRUCTION INSPECTOR. (NO SEPARATE PAY ITEM)
- 14. WHERE THE MINIMUM NINE-FOOT (9') SEPARATION DISTANCE BETWEEN WASTEWATER LINES AND WATER LINES / MAINS CANNOT BE MAINTAINED, THE INSTALLATION OF WASTEWATER LINES SHALL BE IN STRICT ACCORDANCE WITH TCEQ REGULATIONS. THE WASTEWATER LINE SHALL BE CONSTRUCTED OF CAST IRON, DUCTILE IRON, OR PVC MEETING THE ASTM SPECIFICATION FOR BOTH PIPES AND JOINTS OF 150 PSI AND SHALL BE IN ACCORDANCE WITH 30 TAC 217. 53 (D)(3)(A)(I).
- 15. WATER JETTING THE BACKFILL WITHIN A STREET WILL NOT BE PERMITTED. SANITARY SEWER TRENCHES SUBJECT TO TRAFFIC SHALL CONFORM TO THE CITY CONSTRUCTION STANDARDS.
- 16. NO TESTING WILL BE PERFORMED PRIOR TO 30 DAYS FROM COMPLETE INSTALLATION OF THE SANITARY SEWER LINES. THE FOLLOWING SEQUENCE WILL BE STRICTLY ADHERED TO:
- A. PULL MANDREL B. PERFORM AIR TEST
- C. CLEANING OF ANY DEBRIS
- D. FLUSHING OF SYSTEM

E. TV INSPECTION (WITH IN 72 HOURS OF FLUSHING)

- 17. A MINIMUM OF THREE FEET (3') OF COVER IS TO BE MAINTAINED OVER THE SANITARY SEWER MAIN AND LATERALS AT SUBGRADE, OTHERWISE CONCRETE ENCASEMENT WILL BE REQUIRED.
- 18. CLEANOUTS SHALL BE PROVIDED AT THE END OF EACH LINE WHEN A MANHOLE IS NOT REQUIRED. A CI CLEANOUT CASTING ALAMO IRON WORKS NO. 813-45, OR APPROVED EQUAL SHALL BE USED.
- 19. EACH LOT OWNER SHALL BE RESPONSIBLE FOR VERIFYING THE DEPTH OF THE SEWER SERVICE STUB OUT, AND DETERMINE THE MINIMUM SERVICEABLE FINISHED FLOOR ELEVATION.
- 20. VERTICAL SEWER SERVICE STACKS SHALL BE REQUIRED WHERE THE TOP OF THE SEWER MAIN IS AT A DEPTH OF EIGHT FEET (8') OR GREATER, UNLESS SHOWN OTHERWISE ON PLANS.

WATER NOTES:

- 1. ALL WATER MAINS SHALL BE AWWA C900 (CLASS 150 OR GREATER), DR18.
- 2. WATER SERVICES SHALL BE TYPE "K" SOFT COPPER CONFORMING TO ASTM SPECIFICATION B-88t OR LATEST
- 3. WATER MAIN SHALL HAVE A MINIMUM OF 36 INCHES OF COVER, EXCEPT THAT UNDER ROAD SIDE DITCHES AND ROAD CROSSING, ADDITIONAL COVER AND ENCASEMENT IS REQUIRED.
- 4. EACH UNIT WITHIN A DUPLEX, TRIPLEX, FOURPLEX, OR CONDOMINIUM SHALL BE PROVIDED WITH AN INDIVIDUAL WATER METER. A MASTER METER CAN BE CONSIDERED FOR SEPARATE BUILDINGS, HOWEVER, THOSE BUILDINGS MUST BE PLUMBED TO ALLOW SEPARATE METERS FOR FUTURE CONSIDERATION
- 5. CONTRACTOR WILL KEEP THE AREA ON TOP OF AND AROUND THE WATER METER BOX FREE OF ALL OBJECTS AND
- 6. SECONDARY BACKFILL OF WATER LINES SHALL GENERALLY CONSIST OF MATERIAL REMOVED FROM THE TRENCH AND SHALL BE FREE FROM BRUSH, DEBRIS AND TRASH OR STONES HAVING ANY DIMENSION LARGER THAN 4" INCHES AT THE LARGEST DIMENSION.
- 7. HYDROSTATIC TESTING IS DONE FROM VALVE TO VALVE.
- 8. NO METER BOXES TO BE SET IN DRIVEWAYS OR SIDEWALKS. ANY METER BOXES SET IN DRIVEWAYS OR
- SIDEWALKS WILL BE RELOCATED AT CONTRACTOR 'S AND/OR DEVELOPER'S EXPENSE
- 9. METER BOXES MUST BE SET AT THE PROPOSED GRADE. ANY METER BOXES THAT ARE NOT SET AT THE FINAL GRADE WILL BE ADJUSTED AT CONTRACTOR'S AND/OR DEVELOPER'S EXPENSE.
- 10. METER BOXES SHALL BE PLASTIC, WITH COVERS, BY DFW PLASTICS, INC. OR APPROVED EQUAL.
- 11. BRASS STOPS FOR CONNECTING TUBING TO SERVICE CLAMPS SHALL BE MUELLER OR APPROVED EQUAL WITH
- COMPRESSION BY CC THREAD FITTINGS.
- 12. TAPPING SADDLES SHALL BE MUELLER OR APPROVED EQUAL DOUBLE STRAP WITH CC THREAD.
- 13. CONTRACTOR SHALL PLACE TRACER WIRE ON TOP OF THE WATER MAINS. TRACER WIRE SHOULD RUN FROM VALVE TO VALVE AND EXIT AT THE VALVE BOX. THE TRACER WIRE SHOULD BE ATTACHED TO THE TOP OF THE PIPE USING TAPE. EXCESS WIRE SHOULD BE LEFT WITHIN VALVE BOXES TO BE PLACED WITHIN LID OF COVER.

CONSTRUCTION NOTES:

DRAINAGE NOTE

 DRAINAGE IMPROVEMENTS SUFFICIENT TO MITIGATE THE IMPACT OF CONSTRUCTION SHALL BE INSTALLED PRIOR TO ADDING IMPERVIOUS COVER.

UTILITY TRENCH COMPACTION

ALL UTILITY TRENCH COMPACTION TESTS WITHIN THE STREET PAVEMENT SECTION SHALL BE THE RESPONSIBILITY OF THE DEVELOPER'S GEO-TECHNICAL ENGINEER. FILL MATERIAL SHALL BE PLACED IN UNIFORM LAYERS NOT TO EXCEED TWELVE INCHES (12") LOOSE. EACH LAYER OF MATERIAL SHALL BE COMPACTED TO A MINIMUM 95% DENSITY AND TESTED FOR DENSITY AND MOISTURE.

CURB CUT

- DUE TO CONSTRUCTION OF NEW RIGHT-OF-WAY CONSTRUCTION:
- SAWCUT EXISTING STREET AND MATCH TO NEW CONSTRUCTION.
- SAWCUT EXISTING CURB TO TIE INTO EXISTING CONSTRUCTION.

CONSTRUCTION STABILIZED ENTRANCE

- SAWCUT CURB FOR CONSTRUCTION ENTRANCE
- STABILIZED CONSTRUCTION AREA SHALL BE CONSTRUCTED OF 3"X5" ROCK TO BE PLACED A MINIMUM LENGTH OF 25 FEET AND MAINTAINED SO THAT CONSTRUCTION DEBRIS DOES NOT FALL WITH IN THE CITY RIGHT-OF-'WAY RIGHT-OF-WAY MUST BE CLEARED FROM MUD, ROCKS, ETC. AT ALL TIMES.

SIGNING AND PAVEMENT MARKING NOTES

- THE CONTRACTOR SHALL FURNISH AND INSTALL ALL REGULATORY AND WARNING SIGNS, STREET NAME SIGNS AND SIGN MOUNTS IN ACCORDANCE WITH APPROVED ENGINEERING PLANS. THE CITY WILL INSPECT ALL SIGNS AT FINAL INSPECTION.
- THE CONTRACTOR SHALL INSTALL ALL PAVEMENT MARKINGS IN ACCORDANCE WITH APPROVED ENGINEERING PLANS. THE CONTRACTOR SHALL NOTIFY THE CITY AT LEAST TWIENTY-FOUR (24) HOURS PRIOR TO THE INSTALLATION OF ALL SEALER AND FINAL MARKINGS. THE CITY WILL INSPECT ALL MARKINGS AT FINAL APPLICATION.


- THE WEDGE ANCHOR STEEL SYSTEM AND THIN-WALLED TUBING POST SHALL BE USED FOR SIGNS WITH UP TO 10 SQUARE FEET OF SIGN AREA. MATERIALS AND INSTALLATION SHOULD FOLLOW THE TXDOT TRAFFIC STANDARDS.
- THE TRIANGULAR SLIP BASE SYSTEM AND 10 BWG TUBING POST SHALL BE USED FOR SIGNS THAT HAVE 10 TO 16 SQUARE FEET OF SIGN AREA. MATERIALS AND INSTALLATION SHOULD FOLLOW THE CALTRANS TRAFFIC STANDARDS.
- OBJECT MARKERS MATERIALS AND INSTALLATION SHOULD FOLLOW THE CALTRANS TRAFFIC STANDARDS.

 SIGN MATERIALS INCLUDING ALUMINUM SIGN BLANKS AND SIGN FACE MATERIALS SHOULD FOLLOW THE TXDOT TRAFFIC STANDARDS.

SEQUENCE OF CONSTRUCTION

- INSTALL EROSION CONTROLS PER APPROVED PLAN.
- 2. TEMPORARY CONTROLS TO BE INSPECTED AND MAINTAINED WEEKLY AND PRIOR TO ANTICIPATED RAINFALL EVENTS, AND AFTER RAINFALL EVENTS, AS NEEDED. CONTRACTOR/OWNER SHALL PROVIDE A CONTACT NAME AND NUMBER FOR EROSION CONTROL ISSUES.

- CONDUCT DEMOLITION ACTIVITIES, IF APPLICABLE
- CONSTRUCT DETENTION POND PER APPROVED PLAN
- CONDUCT GRADING ACTIVITY IN R.O.W. FOR STREET CONSTRUCTION
- CONDUCT TRENCHING ACTIVITY FOR WATER AND WASTEWATER IMPROVEMENTS.
- RE-VEGETATE DISTURBED AREAS.
- REMOVE EROSION CONTROLS (AS APPLICABLE) WITH COORDINATION OF OWNER REPRESENTATIVE AND ENGINEER.

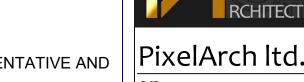

24001 Calle De La Magdalena, unit 3896 Laguna Hills, CA 92653 Tel: (415) 316 7162 nfo@pixelarchltd.com www.pixelarchltd.com




LN, 956

Description Date

COPYRIGHT THIS DRAWING IS AN INSTRUMENT OF SERVICE AND AS SUCH. REMAINS THE PROPERTY OF PIXELARCH LTD. PERMISSION FOR USE OR REPRODUCTION IS LIMITED AND CAN BE EXTENDED ONLY BY WRITTEN PERMISSION WITH OWNER, PIXELARCH LTD.

DRAWING TITLE:

GENERAL NOTES

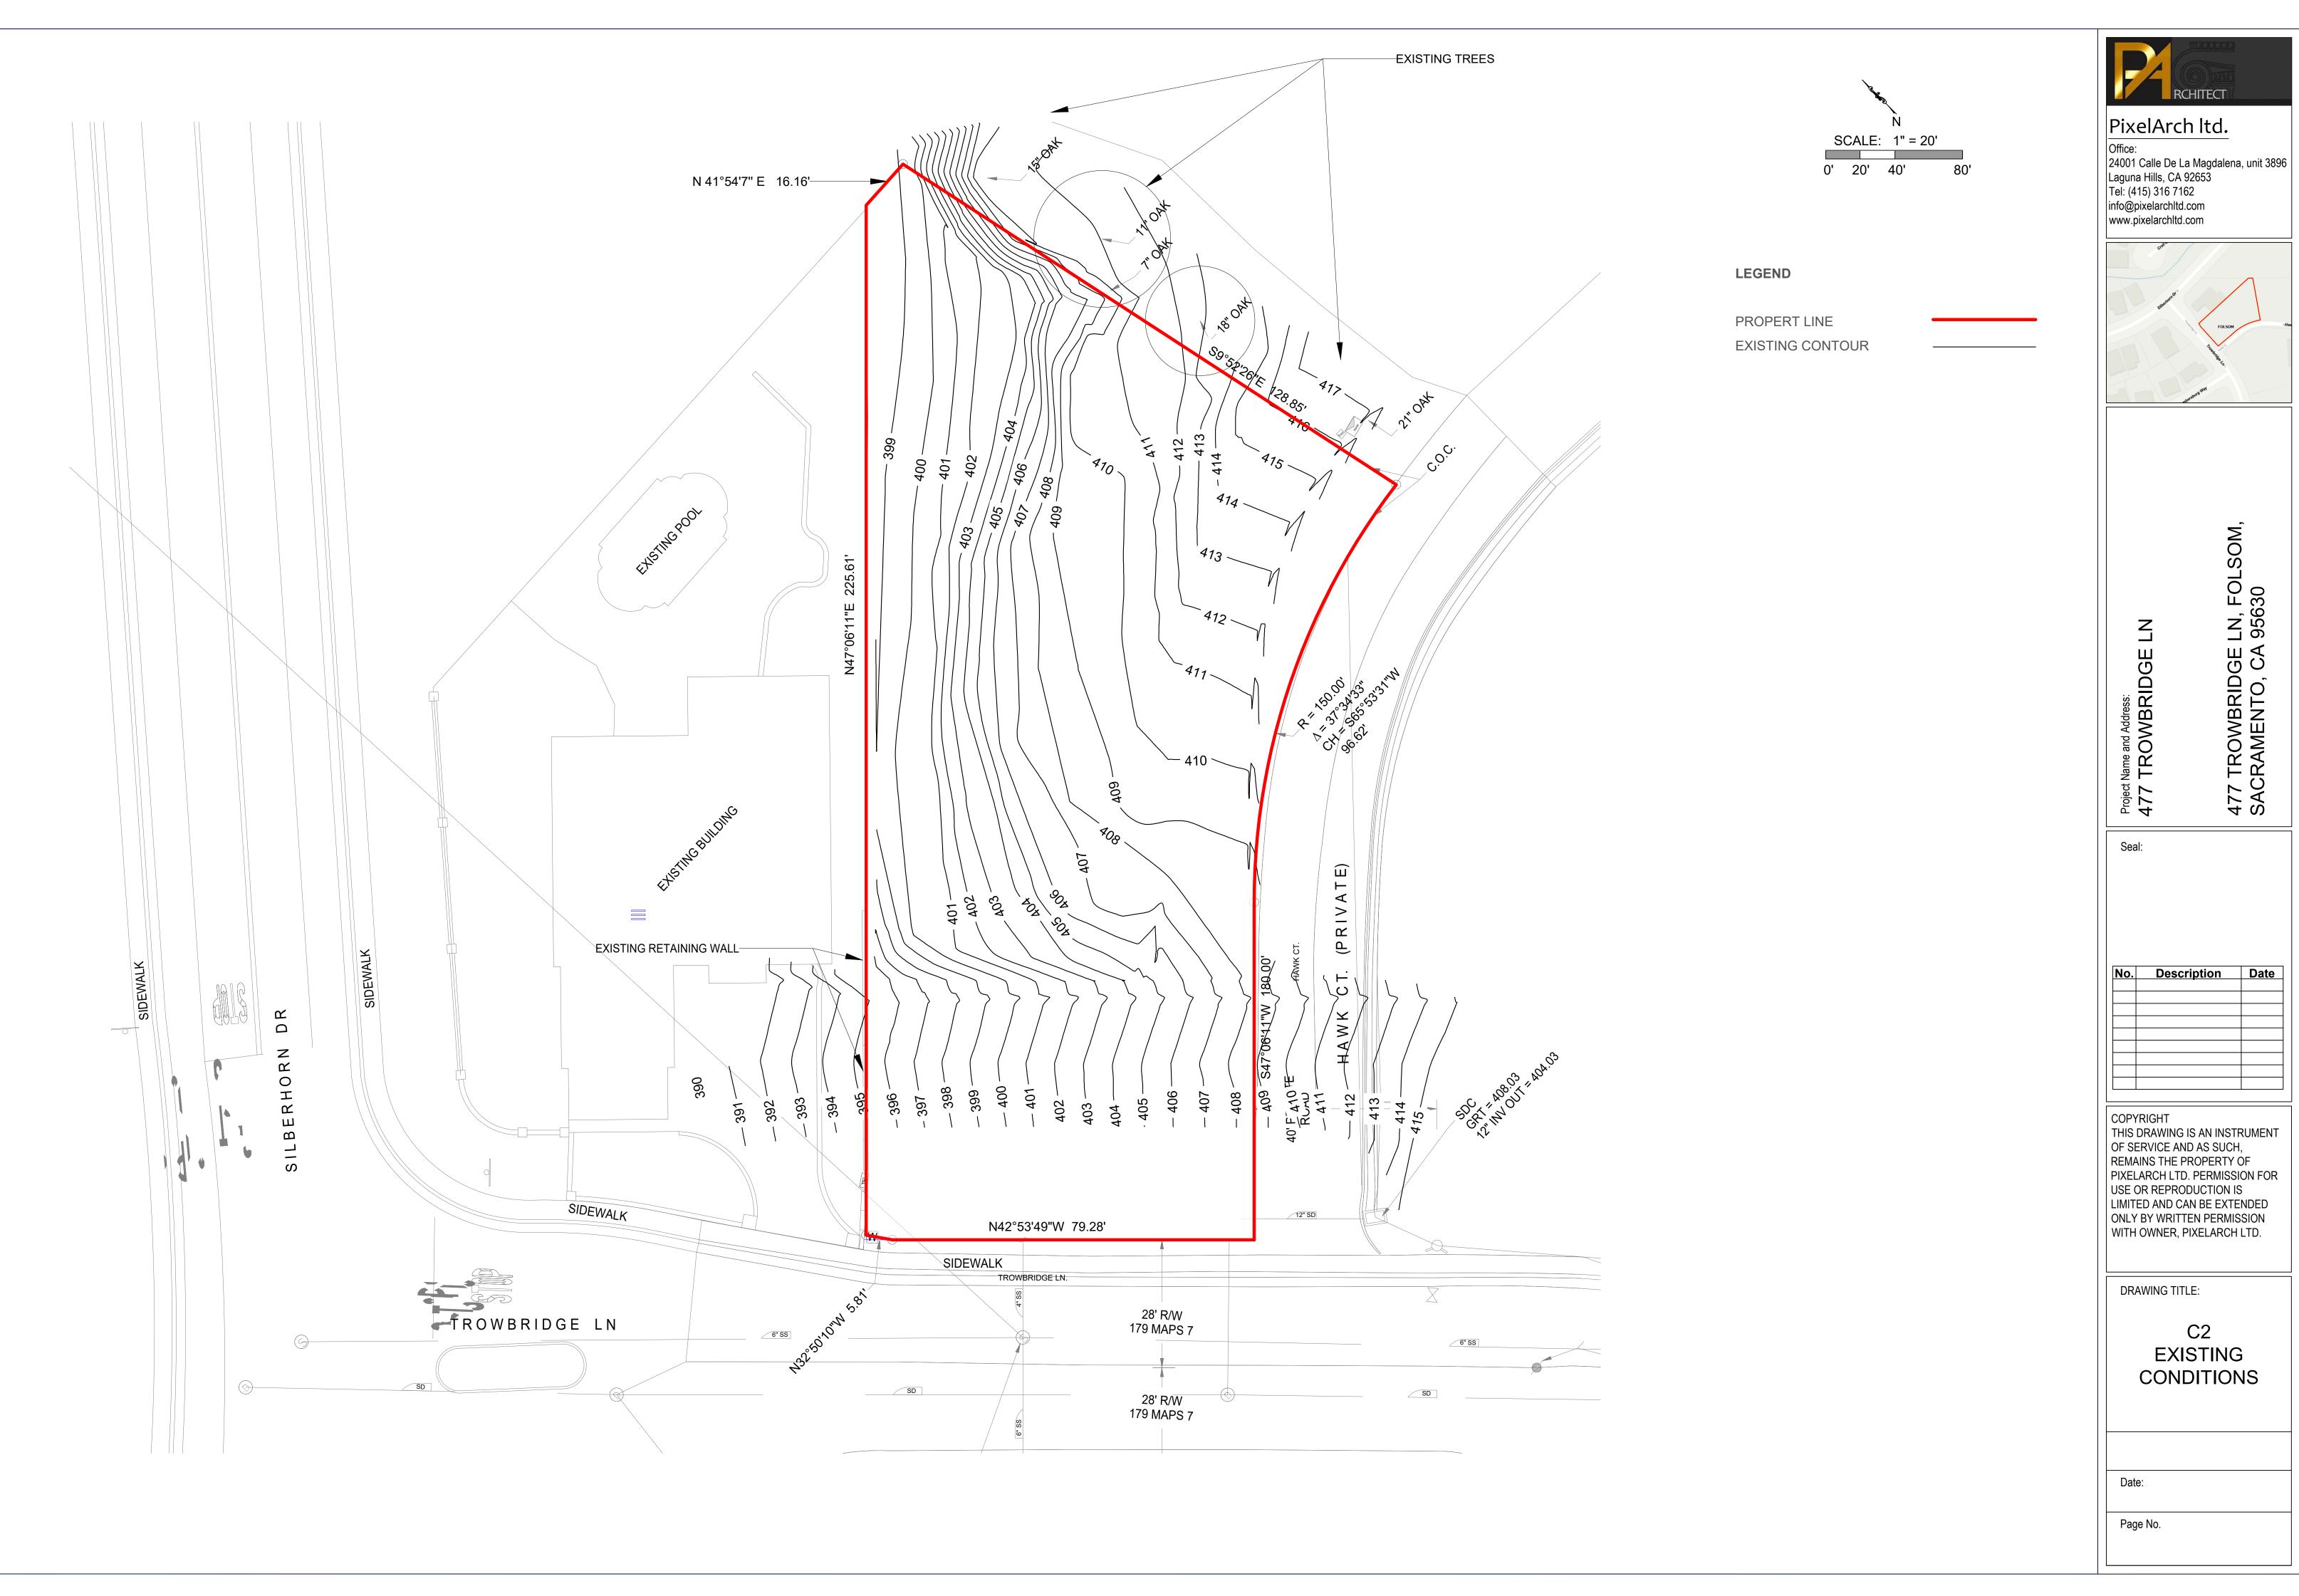





LN, FOLSOM, v 95630 477 TROWBRIDGE SACRAMENTO, CA

No.	Description	Date
	_	

THIS DRAWING IS AN INSTRUMENT OF SERVICE AND AS SUCH,
REMAINS THE PROPERTY OF
PIXELARCH LTD. PERMISSION FOR USE OR REPRODUCTION IS
LIMITED AND CAN BE EXTENDED ONLY BY WRITTEN PERMISSION WITH OWNER, PIXELARCH LTD.

EXISTING

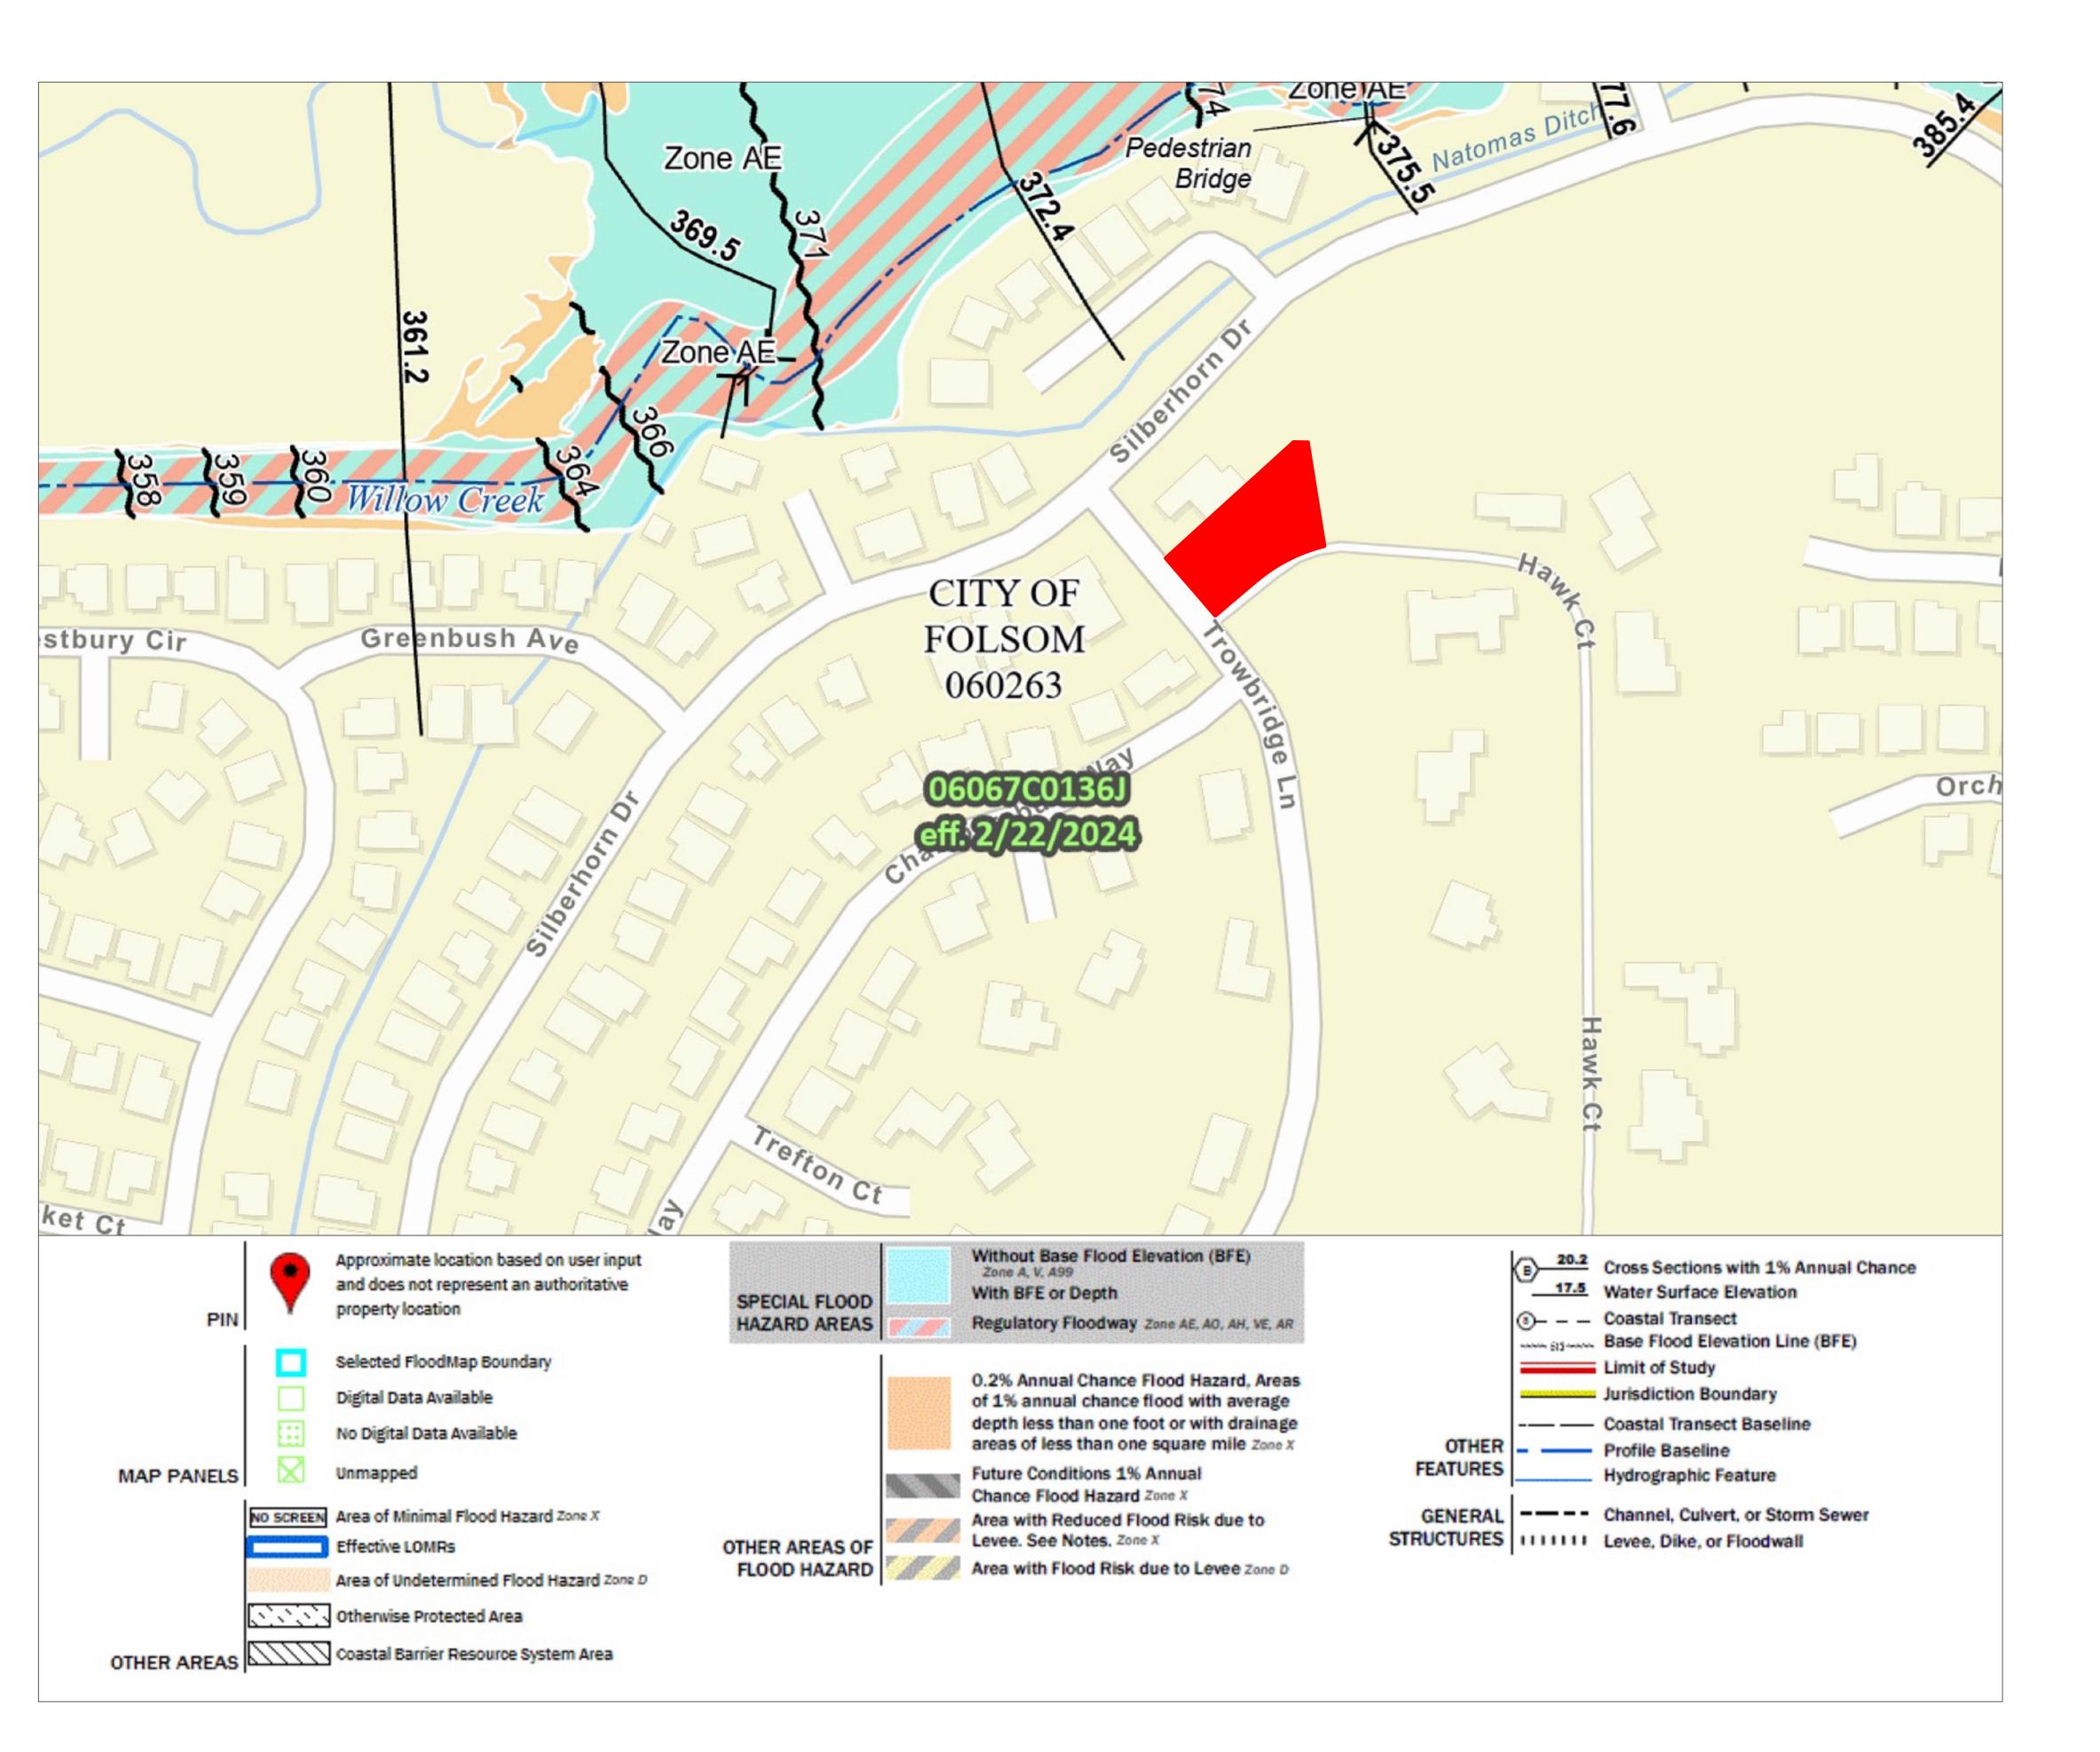

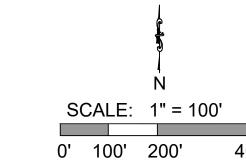

LEGEND

PROPERT LINE





477 TROWBRIDGE LN
477 TROWBRIDGE LN, FOLSON
SACRAMENTO, CA 95630


No.	Description	Date
	-	

COPYRIGHT
THIS DRAWING IS AN INSTRUMENT
OF SERVICE AND AS SUCH,
REMAINS THE PROPERTY OF
PIXELARCH LTD. PERMISSION FOR
USE OR REPRODUCTION IS
LIMITED AND CAN BE EXTENDED
ONLY BY WRITTEN PERMISSION
WITH OWNER, PIXELARCH LTD.


DRAWING TITLE:

C3 FLOOD MAP

Date:

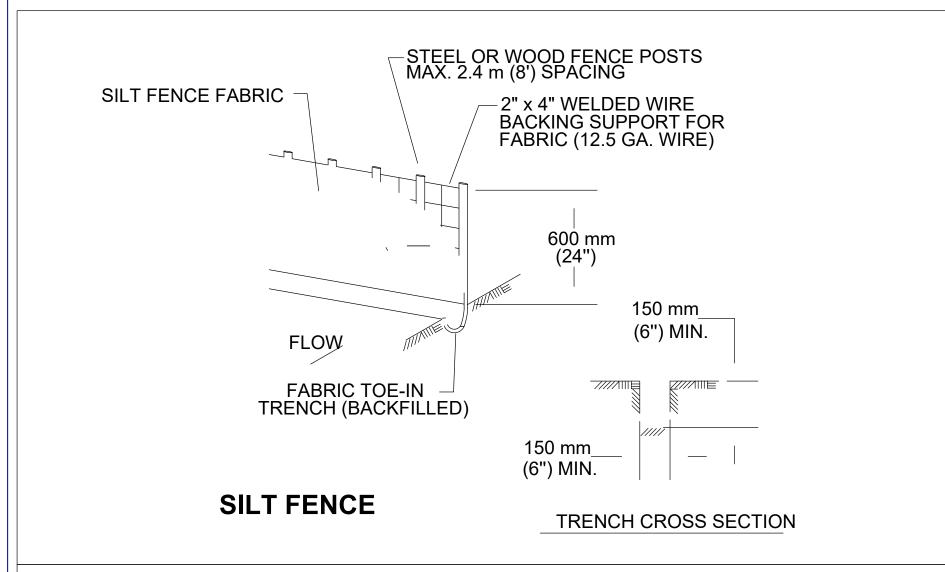

- STEEL OR WOOD POSTS WHICH SUPPORT THE SILT FENCE SHALL BE INSTALLED ON A SLIGHT ANGLE TOWARD THE ANTICIPATED RUNOFF SOURCE. POST MUST BE EMBEDDED A MINIMUM OF 300 mm (12 INCHES). IF WOOD POSTS CANNOT ACHIEVE 300 mm (12 inches) DEPTH, USE STEEL POSTS
- 2. THE TOE OF THE SILT FENCE SHALL BE TRENCHED IN WITH A SPADE OR MECHANICAL TRENCHER. SO THAT THE DOWNSLOPE FACE OF THE TRENCH IS FLAT AND PERPENDICULAR TO THE LINE OF FLOW.
- THE TRENCH MUST BE A MINIMUM OF 150 mm (6 inches) DEEP AND 150 mm (6 inches) WIDE TO ALLOW FOR THE SILT FENCE FABRIC TO BE LAID IN THE GROUND AND BACKFILLED WITH COMPACTED MATERIAL
- SILT FENCE FABRIC SHOULD BE SECURELY FASTENED TO EACH STEEL OR WOOD SUPPORT POST OR TO WOVEN WIRE, WHICH IS IN TURN ATTACHED TO THE STEEL OR WOOD FENCE POST.
- 5. INSPECTION SHALL BE MADE WEEKLY OR AFTER EACH RAINFALL EVENT AND REPAIR OR REPLACEMENT SHALL BE MADE PROMPTY AS NEEDED.
- 6. SILT FENCE SHALL BE REMOVED WHEN THE SITE IS COMPLETELY STABILIZED SO AS NOT TO BLOCK OR IMPEDE STORM FLOW OR DRAINAGE
- ACCUMULATED SILT SHALL BE REMOVED WHEN IT REACHES A DEPTH OF 150 mm (6 inches). THE SILT SHALL BE DISPOSED OF ON AN APPROVED SITE AND IN SUCH A MANNER THAT WILL NOT CONTRIBUTE TO ADDITIONAL SILTATION

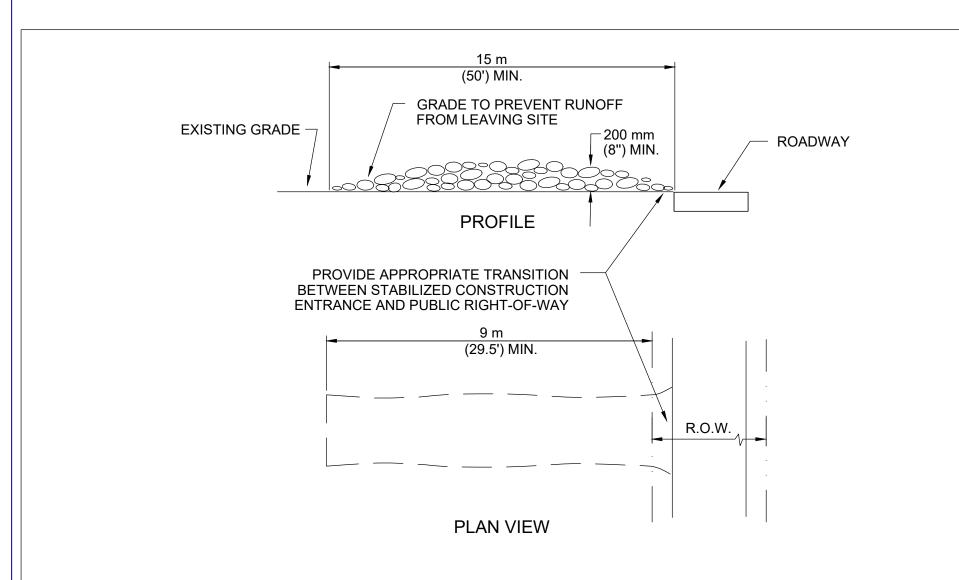

- STONE SIZE: 75-125 mm (3-5") OPEN GRADED ROCK.
- 2. LENGTH: AS EFFECTIVE BUT NOT LESS THAN 9 m (29.5').
- 3. THICKNESS: NOT LESS THAN 200 mm (8").
- 4. WIDTH: NOT LESS THAN FULL WIDTH OF ALL POINTS OF INGRESS/EGRESS.
- WASHING: WHEN NECESSARY, VEHICLE WHEELS SHALL BE CLEANED TO REMOVE SEDIMENT PRIOR TO ENTRANCE ONTO PUBLIC ROADWAY. WHEN WASHING IS REQUIRED, IT SHALL BE DONE ON AN AREA STABILIZED WITH CRUSHED STONE AND DRAINS INTO AN APPROVED TRAP OR SEDIMENT BASIN. ALL SEDIMENT SHALL BE PREVENTED FROM ENTERING ANY STORM DRAIN, DITCH OR WATERCOURSE USING APPROVED METHODS.
- 6. MAINTENANCE: THE ENTRANCE SHALL BE MAINTAINED IN A CONDITION THAT WILL PREVENT TRACKING OR FLOWING OF SEDIMENT ONTO PUBLIC ROADWAY. THIS MAY REQUIRE PERIODIC TOP DRESSING WITH ADDITIONAL STONE AS CONDITIONS DEMAND, AS WELL AS REPAIR AND CLEAN OUT OF ANY MEASURE DEVICES USED TO TRAP SEDIMENT. ALL SEDIMENTS THAT IS SPILLED, DROPPED, WASHED OR TRACKED ONTO PUBLIC ROADWAY MUST BE REMOVED IMMEDIATELY.
- DRAINAGE: ENTRANCE MUST BE PROPERLY GRADED OR INCORPORATE A DRAINAGE SWALE TO PREVENT RUNOFF FROM LEAVING THE CONSTRUCTION SITE.


STABILIZED CONSTRUCTION ENTRANCE

EROSION / SEDIMENTATION CONTROL NOTES:

- 1. ALL TEMPORARY EROSION AND SEDIMENTATION CONTROLS MUST BE INSTALLED PRIOR TO CONSTRUCTION AND SHALL BE MAINTAINED DURING CONSTRUCTION BY THE CONTRACTOR. THE CONTRACTOR SHALL REMOVE THE CONTROLS WHEN VEGETATION IS ESTABLISHED AND THE CONSTRUCTION AREA IS STABILIZED. ADDITIONAL PROTECTION MAY BE REQUIRED IF EXCESSIVE SOLIDS ARE BEING DISCHARGED FROM THE SITE.
- 2. ALL TEMPORARY EROSION AND SEDIMENTATION CONTROLS SHALL BE REMOVED BY THE CONTRACTOR AT FINAL ACCEPTANCE OF THE PROJECT BY THE OWNER / ENGINEER
- 3. PLACEMENT OF TEMPORARY EROSION AND SEDIMENTATION CONTROLS SHALL BE IN ACCORDANCE WITH THE CONSTRUCTION PLANS. ACTUAL LOCATIONS MAY VARY SLIGHTLY FROM THE PLANS BUT WILL BE VERIFIED BY THE ENGINEER/INSPECTOR IN THE FIELD PRIOR TO CONSTRUCTION. THE CONTRACTOR SHALL INSPECT THE CONTROLS AT WEEKLY INTERVALS AND AFTER EVERY SIGNIFICANT RAINFALL TO ENSURE DISTURBANCE OF THE STRUCTURES HAS NOT OCCURRED. SEDIMENT DEPOSITED AFTER A RAINFALL SHALL BE REMOVED FROM THE SITE OR PLACED IN AN ENGINEER APPROVED DESIGNATED DISPOSAL AREA
- CONTRACTOR SHALL BE RESPONSIBLE TO ENSURE THAT NO EROSION CONTROL MEASURES BLOCK THE DRAINAGE SYSTEM FROM WORKING AS DESIGNED
- 5. SEDIMENTS FROM AREAS DISTURBED BY CONSTRUCTION SHALL BE RETAINED ON SITE, USING STRUCTURAL DRAINAGE CONTROLS TO THE MAXIMUM EXTENT PRACTICABLE, AND STOCKPILES OF SOIL SHALL BE PROPERLY CONTAINED TO MINIMIZE SEDIMENT TRANSPORT FROM THE SITE TO STREETS. DRAINAGE FACILITIES. OR ADJACENT PROPERTIES VIA RUNOFF, VEHICLE TRACKING, OR WIND
- CONSTRUCTION-RELATED MATERIALS, WASTES, SPILLS OR RESIDUES SHALL BE RETAINED ON SITE TO MINIMIZE TRANSPORT FROM THE SITE TO STREETS, DRAINAGE FACILITIES, OR ADJOINING PROPERTIES BY WIND OR RUNOFF
- RUNOFF FROM EQUIPMENT AND VEHICLE WASHING SHALL BE CONTAINED AT CONSTRUCTION SITES UNLESS TREATED TO REMOVE SEDIMENTS AND POLLUTANTS.
- 8. PROTECT SLOPES AND CHANNELS.
- PROVIDE STORM DRAIN SYSTEM STENCILING AND SIGNAGE (IF APPLICABLE).
- 10. DIRECT SURFACE FLOW TO VEGETATED AREAS BEFORE DISCHARGE UNLESS THE DIVERSION WOULD RESULT IN SLOPE INSTABILITY.
- 11. PRESERVE EXISTING VEGETATION AT AREAS ON A SITE WHERE NO CONSTRUCTION ACTIVITY IS REQUIRED BY THE CONTRACT
- 12. ON A YEAR-ROUND BASIS, TEMPORARY FENCING SHALL BE INSTALLED AT THE LIMITS CLEARING AND GRUBBING OPERATIONS AND OTHER SOIL-DISTURBING ACTIVITIES. THE TEMPORARY FENCING SHALL BE INSTALLED PRIOR TO COMMENCEMENT OF CLEARING AND GRUBBING OPERATIONS AND OTHER SOIL-DISTURBING ACTIVITIES.
- 13. CLEARING AND GRUBBING OPERATIONS SHALL BE STAGED TO PRESERVE (PROVIDE A SUFFICIENT **EXISTING VEGETATION.**
- 14. PLACE THE SILT FENCES BELOW THE TOE OF EXPOSED AND ERODIBLE CONTAIN THE TRASH SLOPES, DOWN-SLOPE OF EXPOSED SOIL AREAS, AROUND TEMPORARY GENERATED BY THE STOCKPILES, ALONG STREAMS AND CHANNELS, ALONG THE PERIMETER OF PROJECT.) THE BUILDINGS.

LID CONTROL MEASURES


- 1. THE PROPSOED STORAGE AREA SHALL BE PAVED WITH PORTLAND CEMENT CONCRETE OR AN EQUIVALENT IMPERVIOUS SURFACE. CHEMICALLY-RESISTANT TO THE MATERIALS BEING STORED.
- 1.1. NOTE: PLACE MATERIALS IN AN ENCLOSURE SUCH AS A SHED, CABINET, OR OTHER STRUCTURE THAT PREVENTS CONTACT WITH STORMWATER RUNOFF; OR COVER ENTIRE STORAGE AREA WITH A PERMANENT CANOPY, ROOF, OR AWNING TO PREVENT PRECIPITATION FROM MAKING DIRECT CONTACT WITH AND COLLECTING WITHIN THE STORAGE AREA.
- 1.2. DIRECT STORMWATER RUNOFF FROM THE COVER AWAY FROM THE STORAGE AREA TO A STORMWATER RUNOFF DISPOSAL POINT THAT MEETS ALL APPLICABLE CODE, ORDINANCE, AND LID STANDARDS MANUAL REQUIREMENTS. FOR COVER STRUCTURES THAT DO NOT INCLUDE SIDEWALLS, INCLUDE A ROOF OVERHANG THAT EXTENDS BEYOND THE GRADE BREAK.
- CONSTRUCT/PAVE OUTDOOR TRASH STORAGE AND WASTE HANDLING AREA WITH PORTLAND CEMENT CONCRETE OR AN EQUIVALENT IMPERVIOUS SURFACE
- 3. NO VEHICLE AND EQUIPMENT REPAIR/MAINTENANCE SHALL BE CONDUCTED AT THE SITE.
- WASHING VEHICLES, EQUIPMENT, AND ACCESSORIES IN AREAS WHERE WASH WATER FLOWS ONTO THE GROUND IS PROHIBITED.
- DO NOT ALLOW IRRIGATION RUNOFF FROM THE LANDSCAPED AREA TO DRAIN DIRECTLY TO STORM DRAIN SYSTEM. TH MINIMIZE USE OF FERTILIZER, PESTICIDES, AND HERBICIDES ON LANDSCAPED AREAS.

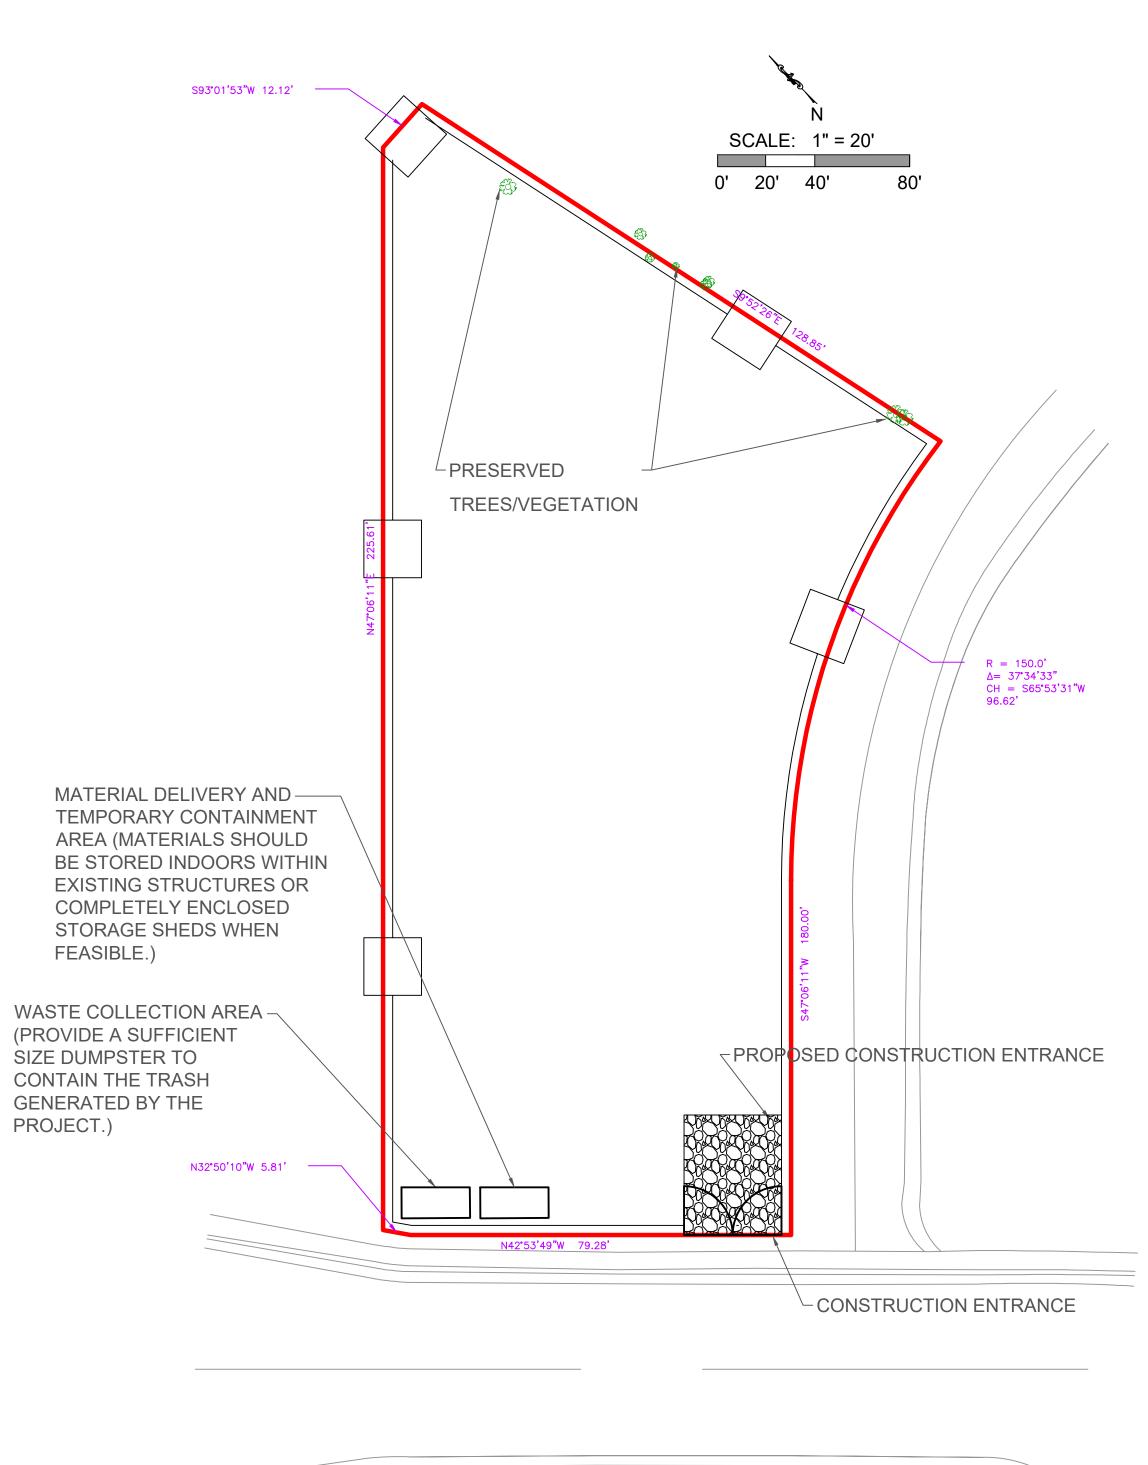



PROPERT LINE SILT FENCE

STABILIZED CONSTRUCTION **ENTRANCE**

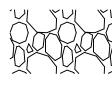



PixelArch Itd.

24001 Calle De La Magdalena, unit 3896 Laguna Hills, CA 92653 Tel: (415) 316 7162 info@pixelarchltd.com www.pixelarchltd.com




No. Description Date

THIS DRAWING IS AN INSTRUMENT OF SERVICE AND AS SUCH. REMAINS THE PROPERTY OF PIXELARCH LTD. PERMISSION FOR USE OR REPRODUCTION IS LIMITED AND CAN BE EXTENDED ONLY BY WRITTEN PERMISSION WITH OWNER, PIXELARCH LTD.

DRAWING TITLE:

C4 **EROSION &** SEDIMENTATION **CONTROL & LID**

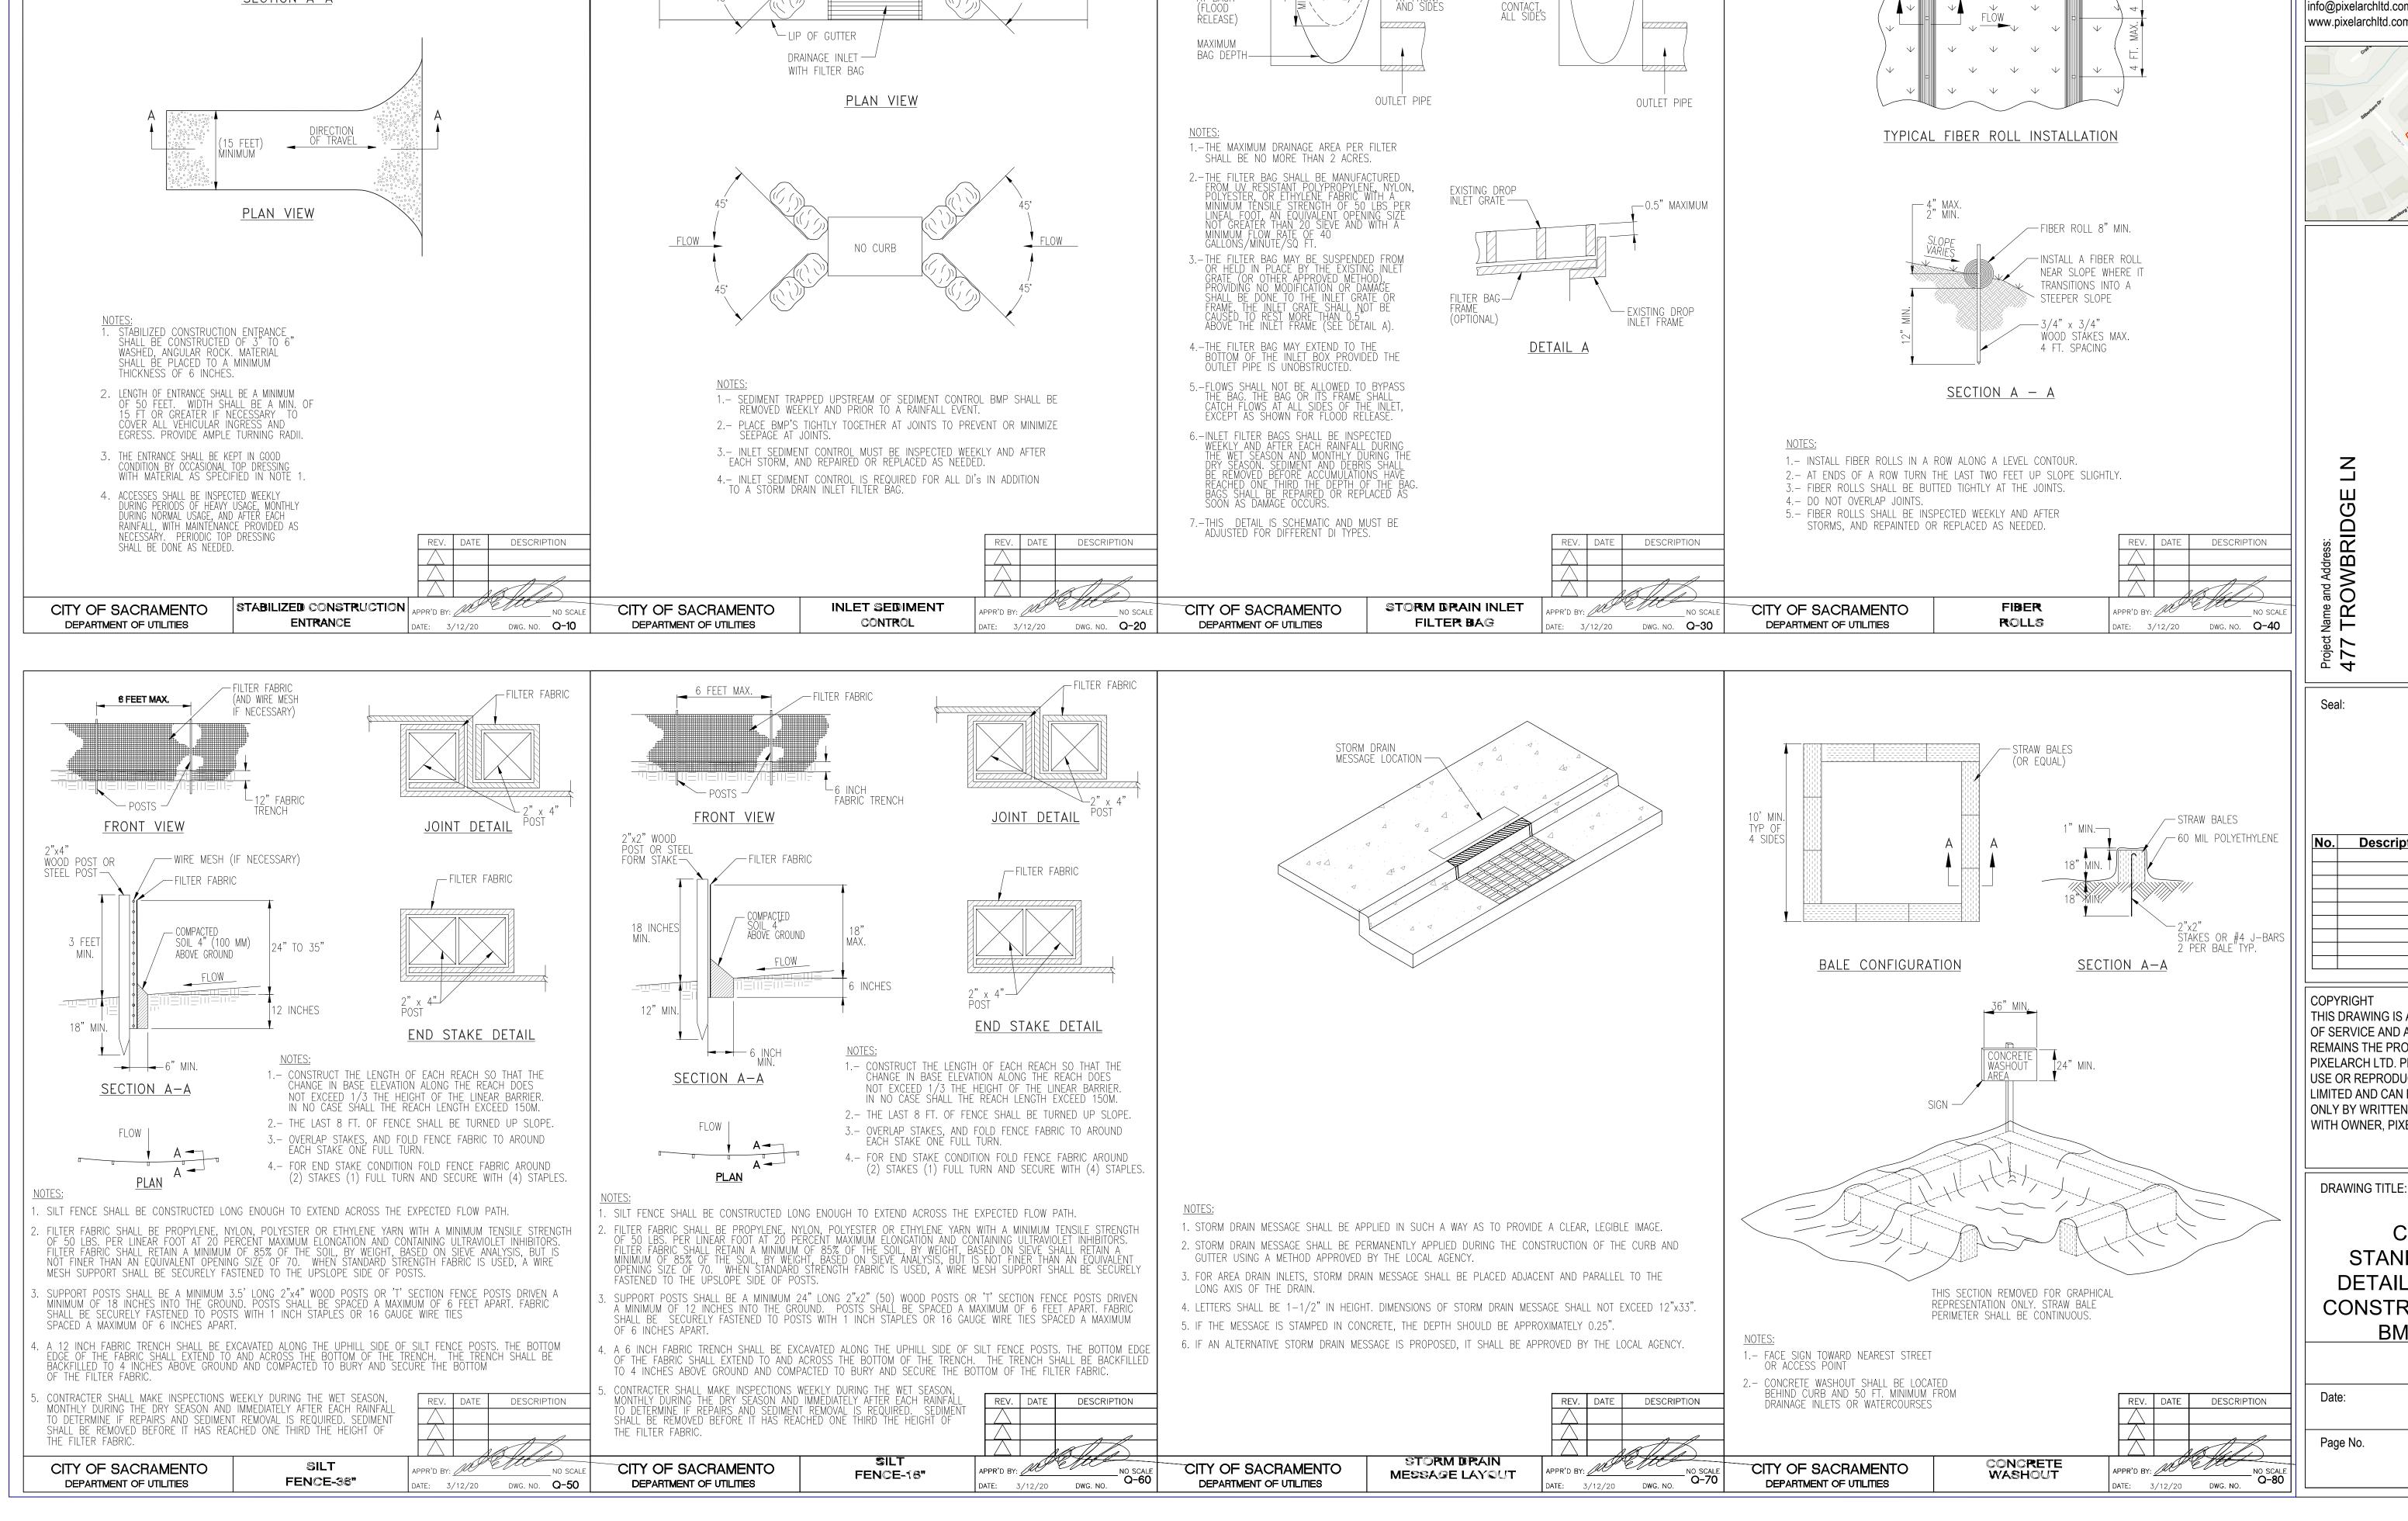

BACK HOOD-

MINIMUM

BACK---

GRAVEL BAG(S) OR OTHER ACCEPTED

SEDIMENT CONTROL BMP. PLACE BAGS

—SEE NOTE 2

TIGHT AGAINST FACE OF CURB.

BACK OF CURB

-FACE OF CURB

____2" MINIMUM ___DETAIL A

(BACK OF

ĠRATE)

- DETAIL A

CURB —

CONSTRUCTION SITE | RIGHT OF WAY

50 FT MINIMUM

6 INCHES (150 MM) MIN.

3"TO 6"WASHED. ANGULAR ROCK —

SECTION A-A

GEOTEXTILE MATERIAL —

CONSTRUCTION **BMPs**

STANDARD DETAILS FOR

USE OR REPRODUCTION IS LIMITED AND CAN BE EXTENDED ONLY BY WRITTEN PERMISSION WITH OWNER, PIXELARCH LTD.

THIS DRAWING IS AN INSTRUMENT OF SERVICE AND AS SUCH, REMAINS THE PROPERTY OF PIXELARCH LTD. PERMISSION FOR

Description Date

TROWBRIDG RAMENTO, 77 A .4 S

FOL


LN, 956

24001 Calle De La Magdalena, unit 3896 Laguna Hills, CA 92653 Tel: (415) 316 7162 info@pixelarchltd.com www.pixelarchltd.com



VERTICAL SPACING MEASURED ALONG THE FACE OF THE SLOPE

VARIES BETWEEN 8 FT.-20 FT.

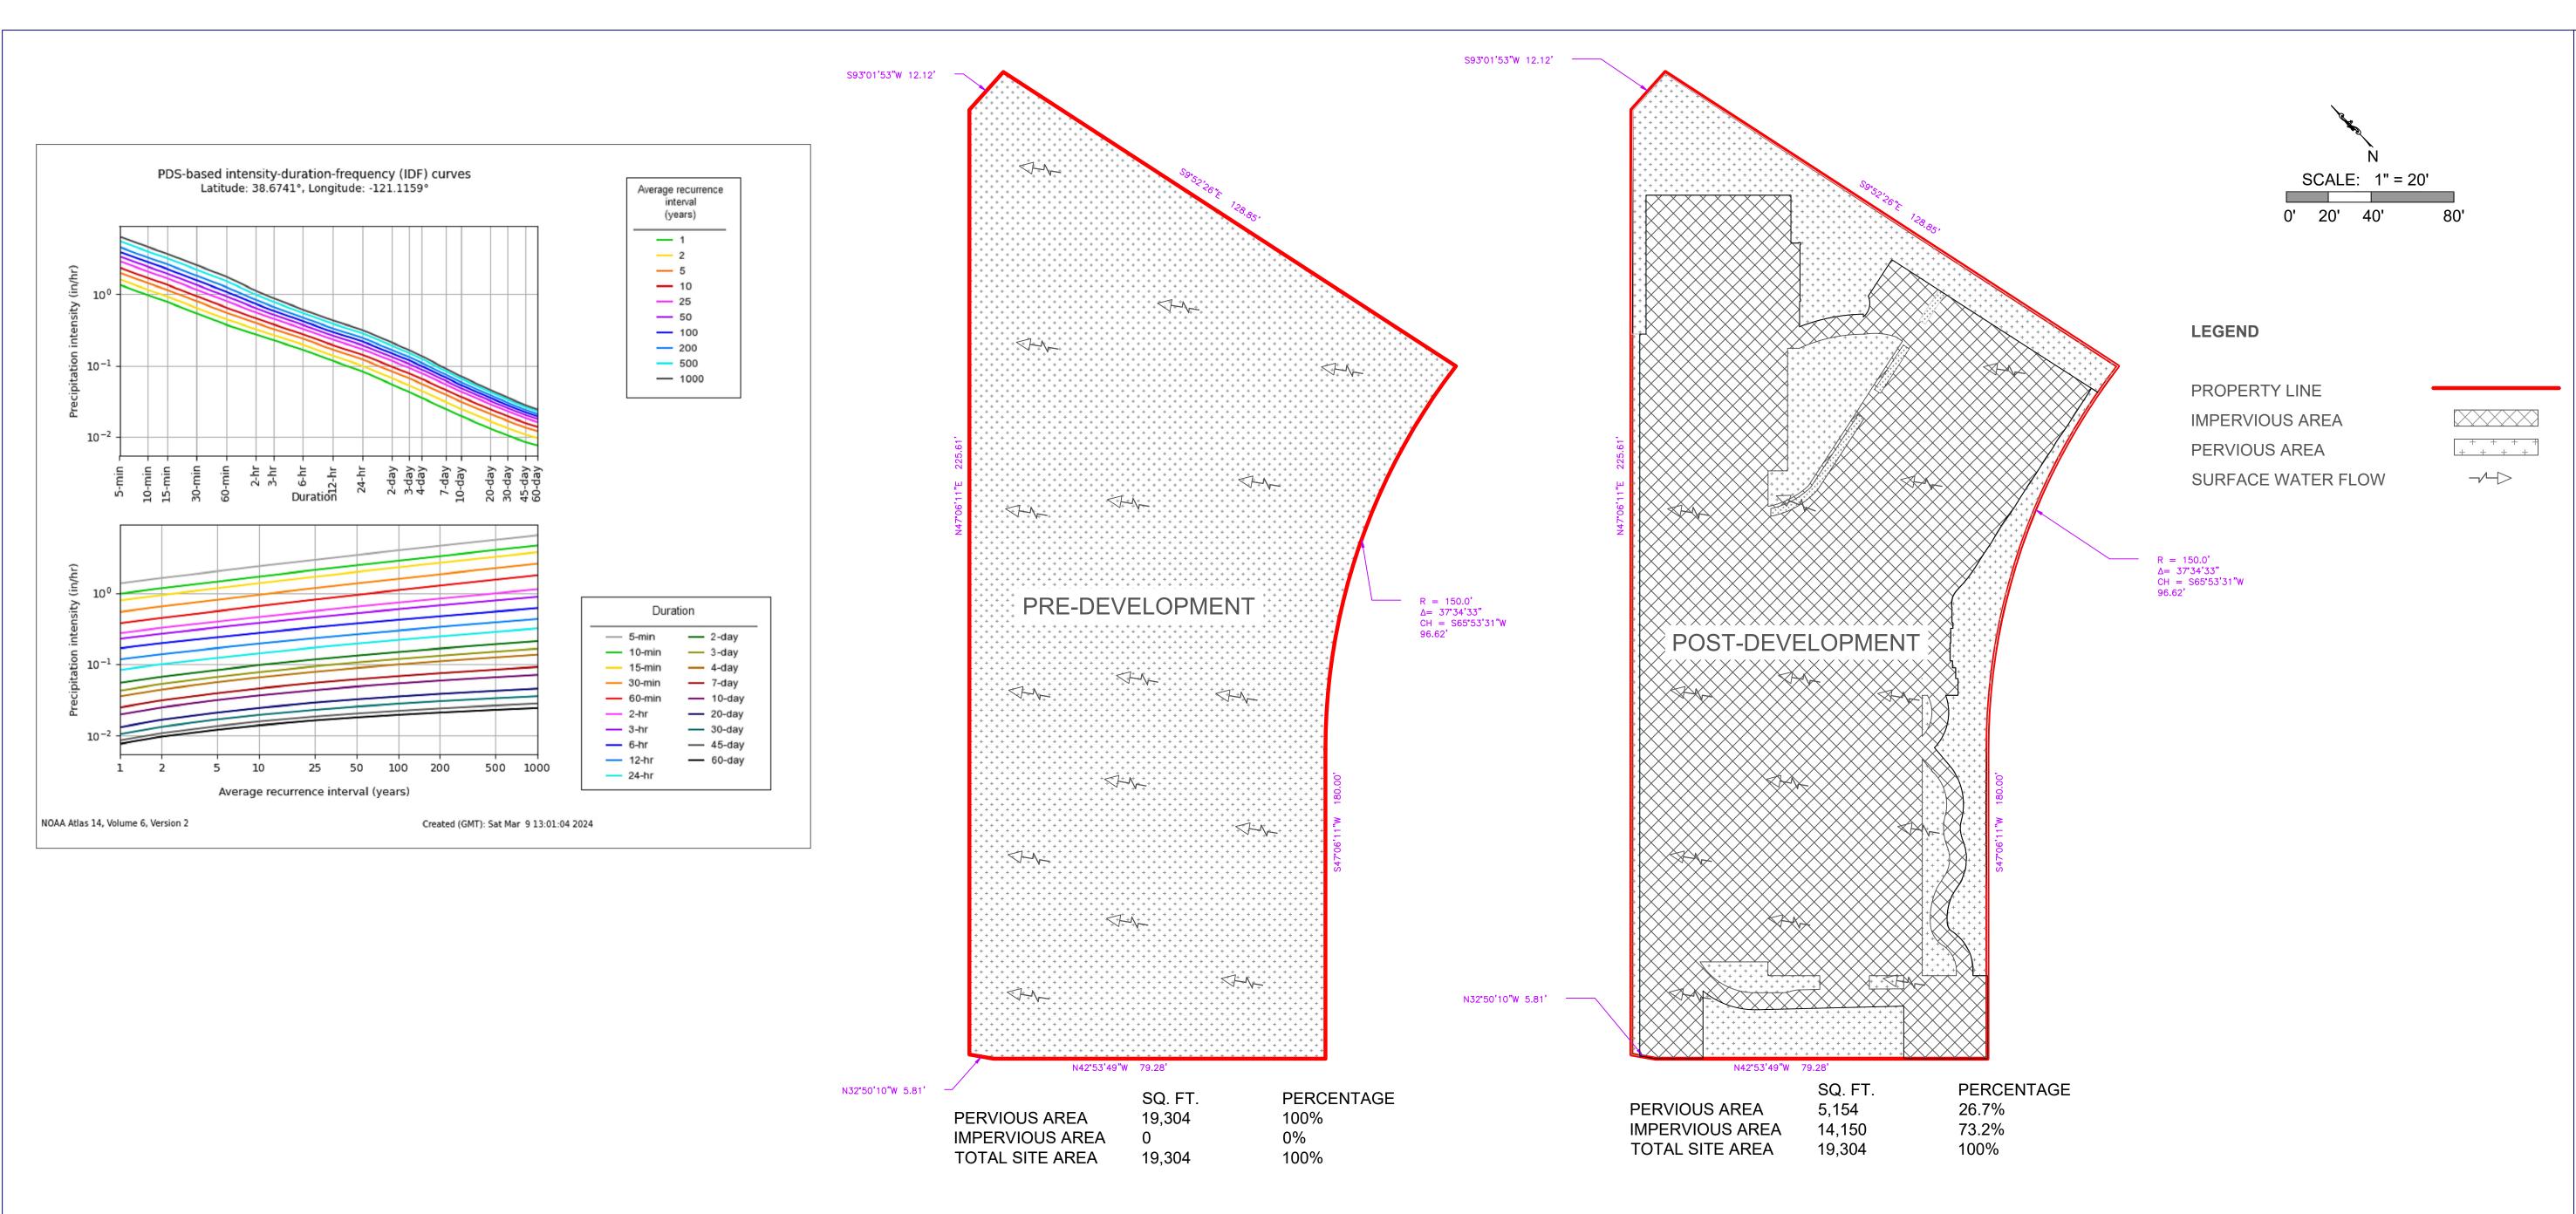

TOTAL DRAINAGE AREA	= 0.443 ac							
	IMPERVIOUS AREA (ACRES - %)	PERVIOUS AREA (ACRES - %)	FLOW LENGTH (FT)	AVERAGE SLOPE (%)	WEIGHTED RUNOFF COEF.	PEAK RU 5-YR	JNOFF (CFS) 25-YR	100-YR
PRE-DEVELOPMENT POST-DEVELOPMENT DIFFERENCE	0.000 (0%) 0.349 (73.5%)	0.443 (100%) 0.117 (26.5%)	124 124	1.45 1.45	0.16 0.64	0.070 0.393 0.323	0.102 0.575 0.473	0.138 0.778 0.640

The peak flow is analyzed based on

5-YR Storm with rainfall intensity of 1.43 in/hr, 25-YR Storm with rainfall intensity of 2.09 in/hr, 100-YR Storm with rainfall intensity of 2.83 in/hr

Note: Participaton Intensity values are obtained from NOAA Atlas (https://hdsc.nws.noaa.gov/hdsc/pfds/pfds_map_cont.html). Location information: Latitude: 38.6741° Longitude: -121.1159° Elevation: 408 ft

HYDROGRAPH REPORT

HYDROGRAPH TYPE: CATCH BASIN AREA:

RUNOFF VOLUME:

PEAK FLOW:

RATIONAL 0.443 ac

0.138 cfs

82.8 cu. ft.

PRE-DEVELOP.


TIME OF CONC. (T_C): 10 min

POST-DEVELOP. P

STORM FREQUENCY: 100-yr

WITHOUT MITIGATION
0.778 cfs
466.8 cu. ft.

POST-DEVELOP.
WITH MITIGATION
0.306 cfs
184 cu. ft.

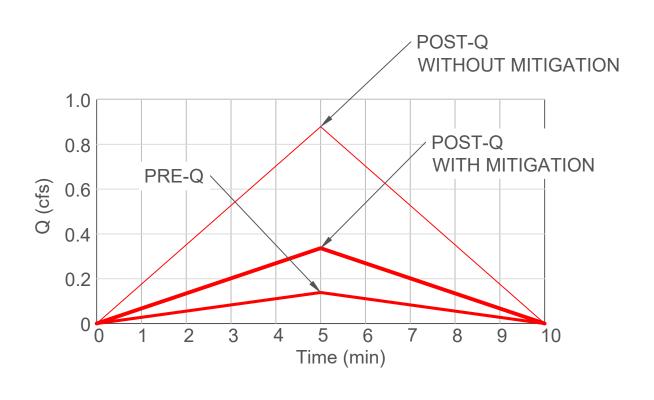



Office:
24001 Calle De La Magdalena, unit 3896
Laguna Hills, CA 92653
Tel: (415) 316 7162
info@pixelarchltd.com
www.pixelarchltd.com



477 TROWBRIDGE LN, FOLSOM, SACRAMENTO, CA 95630

of Name and Address:


No. Description Date


COPYRIGHT
THIS DRAWING IS AN INSTRUMENT
OF SERVICE AND AS SUCH,
REMAINS THE PROPERTY OF
PIXELARCH LTD. PERMISSION FOR
USE OR REPRODUCTION IS
LIMITED AND CAN BE EXTENDED
ONLY BY WRITTEN PERMISSION
WITH OWNER, PIXELARCH LTD.

DRAWING TITLE:

C6 DRAINAGE PLAN


Date:

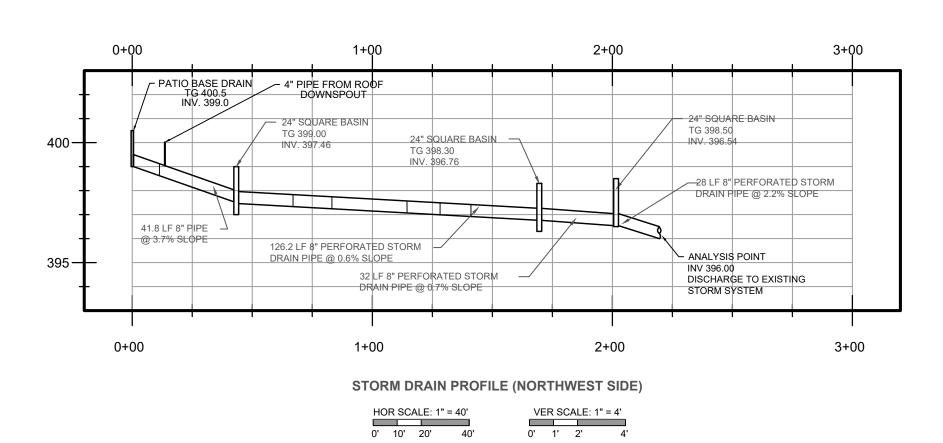

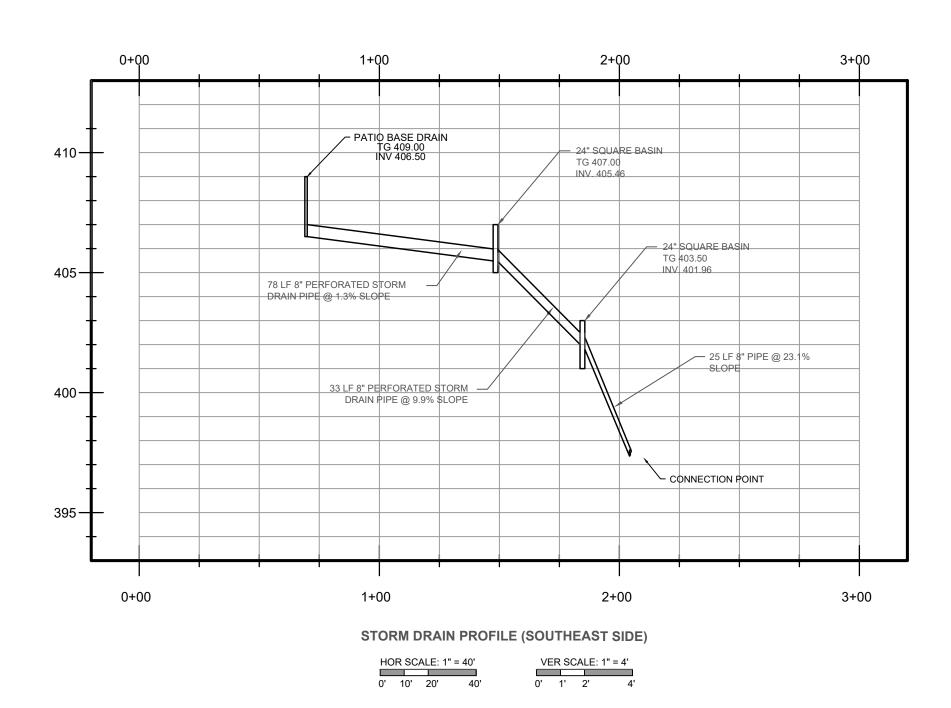

NOTE 1:THE PROPOSED DETENTION POND HAS A VOLUME OF 930 CU.FT. ASSUMING A 35% VOID RATIO AFTER FILLING, THE EFFECTIVE STORAGE VOLUME FOR STORM WATER DETENTION IS ESTIMATED TO BE APPROXIMATELY 325.5 CU.FT. THE POST-DEVELOPMENT RUNOFF VOLUME FOR A 100-YEAR STORM IS 527 CU.FT. AFTER CONSIDERING MITIGATION MEASURES, THE RUNOFF VOLUME IS EXPECTED TO BE REDUCED TO 201.5 CU.FT.


DRAINAGE MITIGATION RESULTS -100(YEAR) Tc 10= MIN				
	PEAK FLOW	RUN OFF-VOLUME		
PRE-DEVELOPMENT	0.138 CFS	82.8 CU. FT.		
POST-DEVELOPMENT(ANALYSIS POINT)	0.878 CFS	527 CU. FT.		
POST-DEVELOPMENT WITH MITIGATION (ANALYSIS POINT)	0.336 CFS	201.5 CU.FT.		

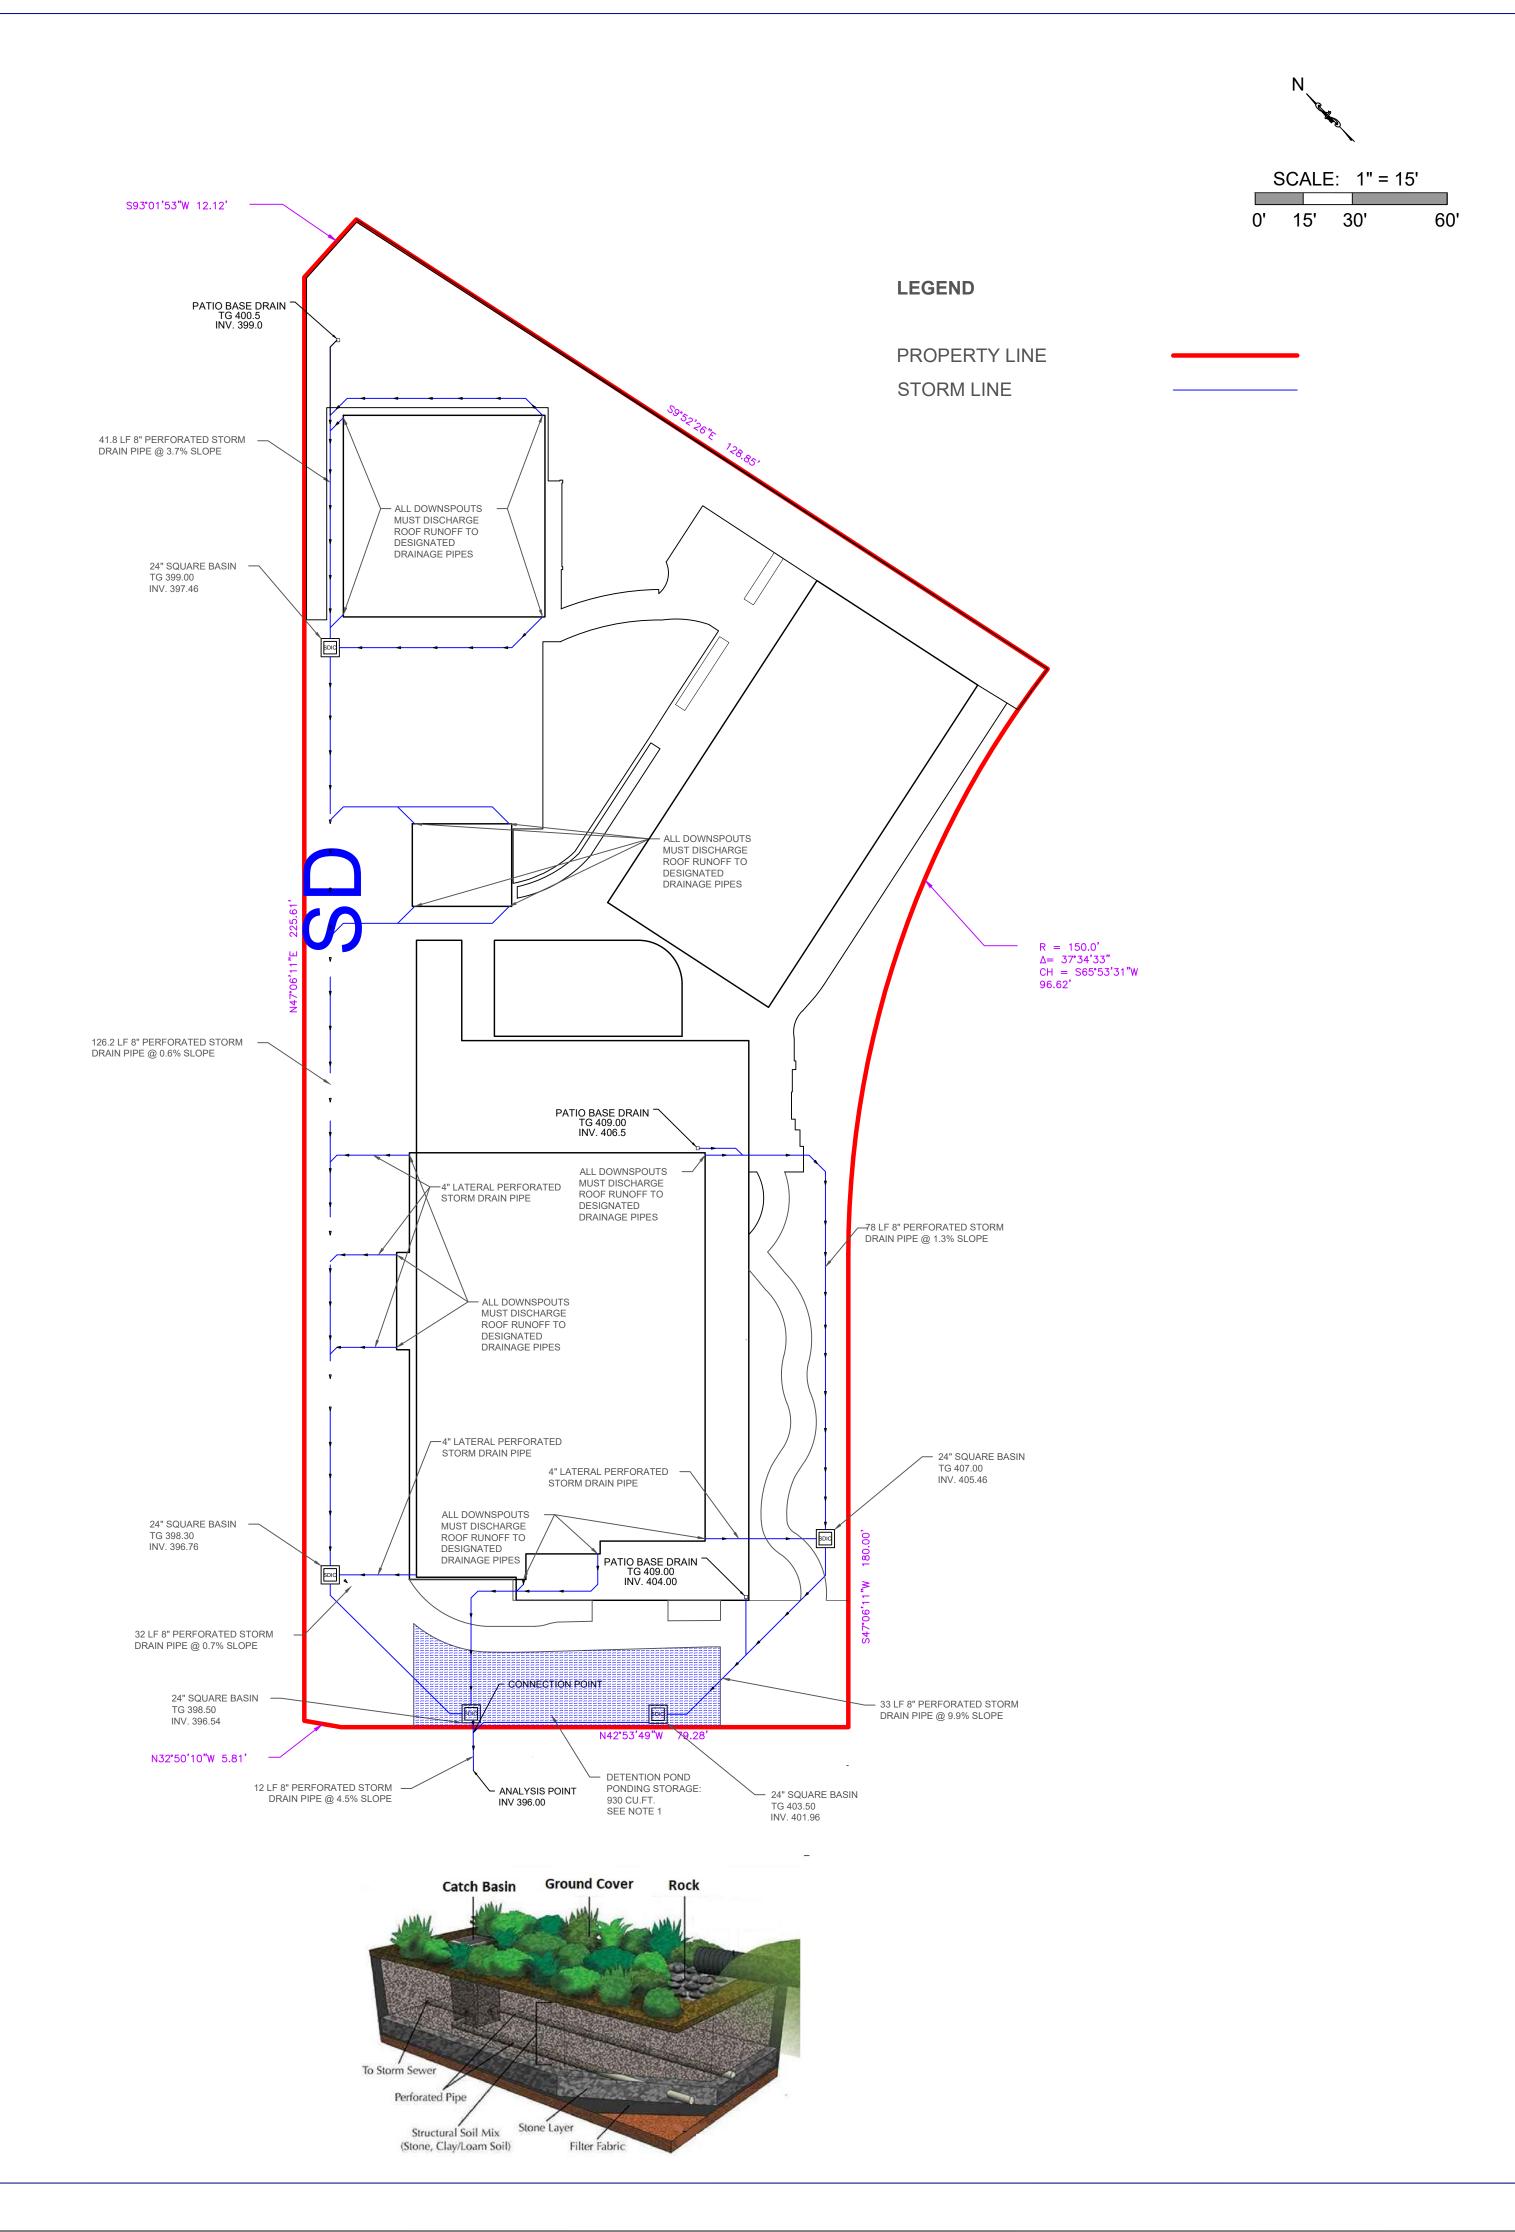



PixelArch ltd.

Office:
24001 Calle De La Magdalena, unit 3896
Laguna Hills, CA 92653
Tel: (415) 316 7162
info@pixelarchltd.com
www.pixelarchltd.com

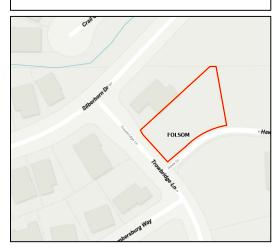

477 TROWBRIDGE LN, FOLSOM, SACRAMENTO, CA 95630

Project Name and Address: 477 TROWBRIDGE


No. Description Date

COPYRIGHT
THIS DRAWING IS AN INSTRUMENT
OF SERVICE AND AS SUCH,
REMAINS THE PROPERTY OF
PIXELARCH LTD. PERMISSION FOR
USE OR REPRODUCTION IS
LIMITED AND CAN BE EXTENDED
ONLY BY WRITTEN PERMISSION
WITH OWNER, PIXELARCH LTD.

DRAWING TITLE:

C7 STORM WATER MANAGEMENT PLAN

Date:

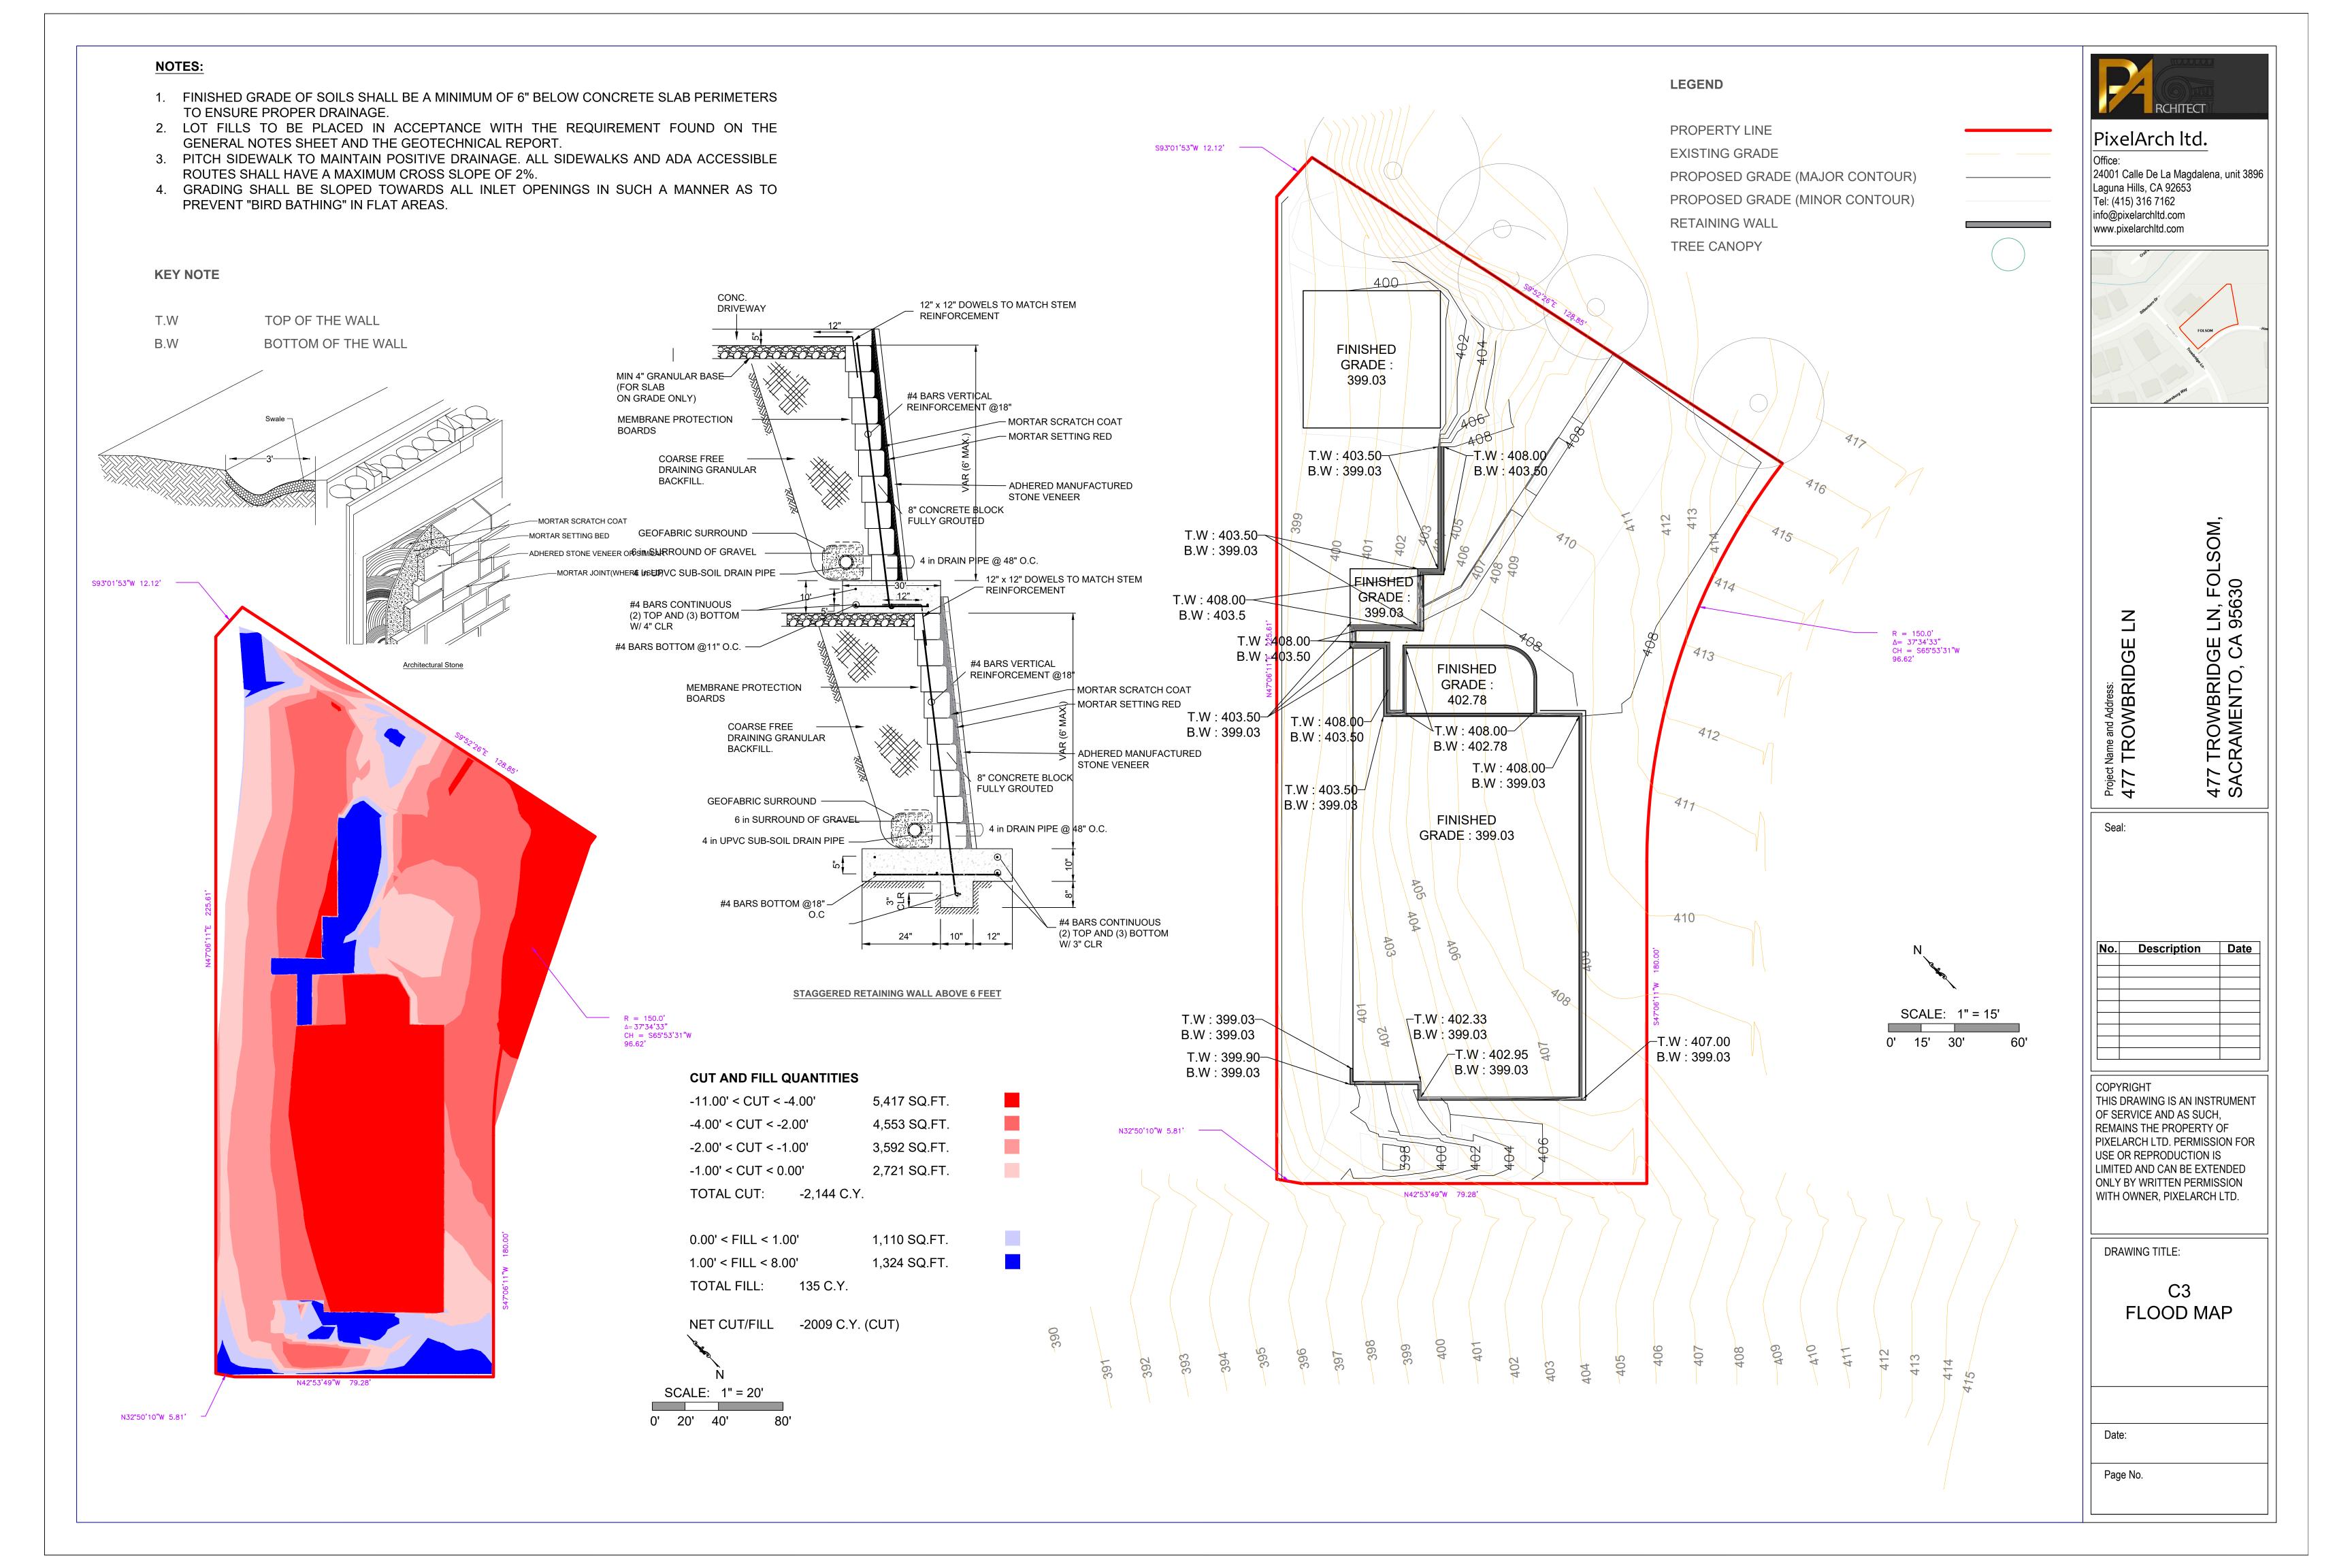

REINFORCEMENT STEEL & FIBERMESH NOTES


- 1. ALL STEEL REINFORCING BARS SHALL BE NEW DOMESTIC DEFORMED BILLET STEEL CONFORMING TO ASTM A615, (#3 AND #4 = GRADE 40) (#5 AND LARGER - GRADE 60) ALL REINFORCEMENT SPECIFICALLY NOTED ON THE DRAWING AS BEING WELDED SHALL BE DOMESTIC STEEL CONFORMING TO ASTM A615, GRADE 40 OR DOMESTIC STEEL CONFORMING TO ASTM A706
- 2. DETAILING OF CONCRETE REINFORCEMENT AND ACCESSORIES SHALL BE IN ACCORDANCE WITH ACL 315.
- 3. ALL REINFORCEMENT BARS LAPS SHALL BE SPLICED A MINIMUM OF 40 BAR DIAMETERS.
- PROTECTION COVER OF REINFORCEMENT SHALL BE AS NOTED BELOW. CONCRETE
- 6. OWNER'S ALTERNATE FIBERMESH CONCRETE MAY BE USED IN LIEU FOR REINFORCEMENT STEEL SPECIFIED IN THE CONCRETE AT THE THICKNESS INDICATED ON THE PLANS AT THE DUMPSTER AREA WHERE 8" CONCRETE IS SPECIFIED USE FIBERMESH #3 @ 24" 0.C.E.W.
- 7. FIBERMESH FIBERS SHALL BE ADDED TO THE CONCRETE MIXTURE AT THE READY MIX

JOINT NOTES

PRIVATE CONCRETE PAVING NOTES

- 1. CONCRETE PAVEMENT SHALL CONFORM TO THE LATEST BUILDING CODE FOR REINFORCED CEMENT CONCRETE INSTITUTE (A.C.I. 318). IF THE FIBERMESH CONCRETE ALTERNATE IS USED, THE CONTRACTOR SHALL ADHERE STRICTLY TO THE MANUFACTURER'S RECOMMENDATIONS AS TO TYPE AND AMOUNT.
- 2. CONCRETE PAVING SHALL BE 8" THICK WITH 3000 PSI MIN AT 28 DAYS AND SHALL HAVE SAND AND GRAVEL OR CRUSHED STONE AGGREGATES TYPE 1 OR 11 PORTLAND CEMENT

- 1 1/2 INCH NOMINAL AGGREGATE SIZE ----- 3% TO 6%
- CONCRETE APPROACH TO BE CONSTRUCTED IN ACCORDANCE WITH THE CITY OF DALLAS STANDARDS.
- SLOPE OF H.C. RAMP DOWN AT ENTRANCE AND SIDE DISPLAY SHALL NOT EXCEED A SLOPE OF 1'/12'
- ALL CONCRETE PAVEMENT TO HAVE A SUB BASE OF 6" THICK LIME STABILIZED SOIL TO BE COMPACTED TO MIN DENSITY OF 98% OF ASTM D-638.

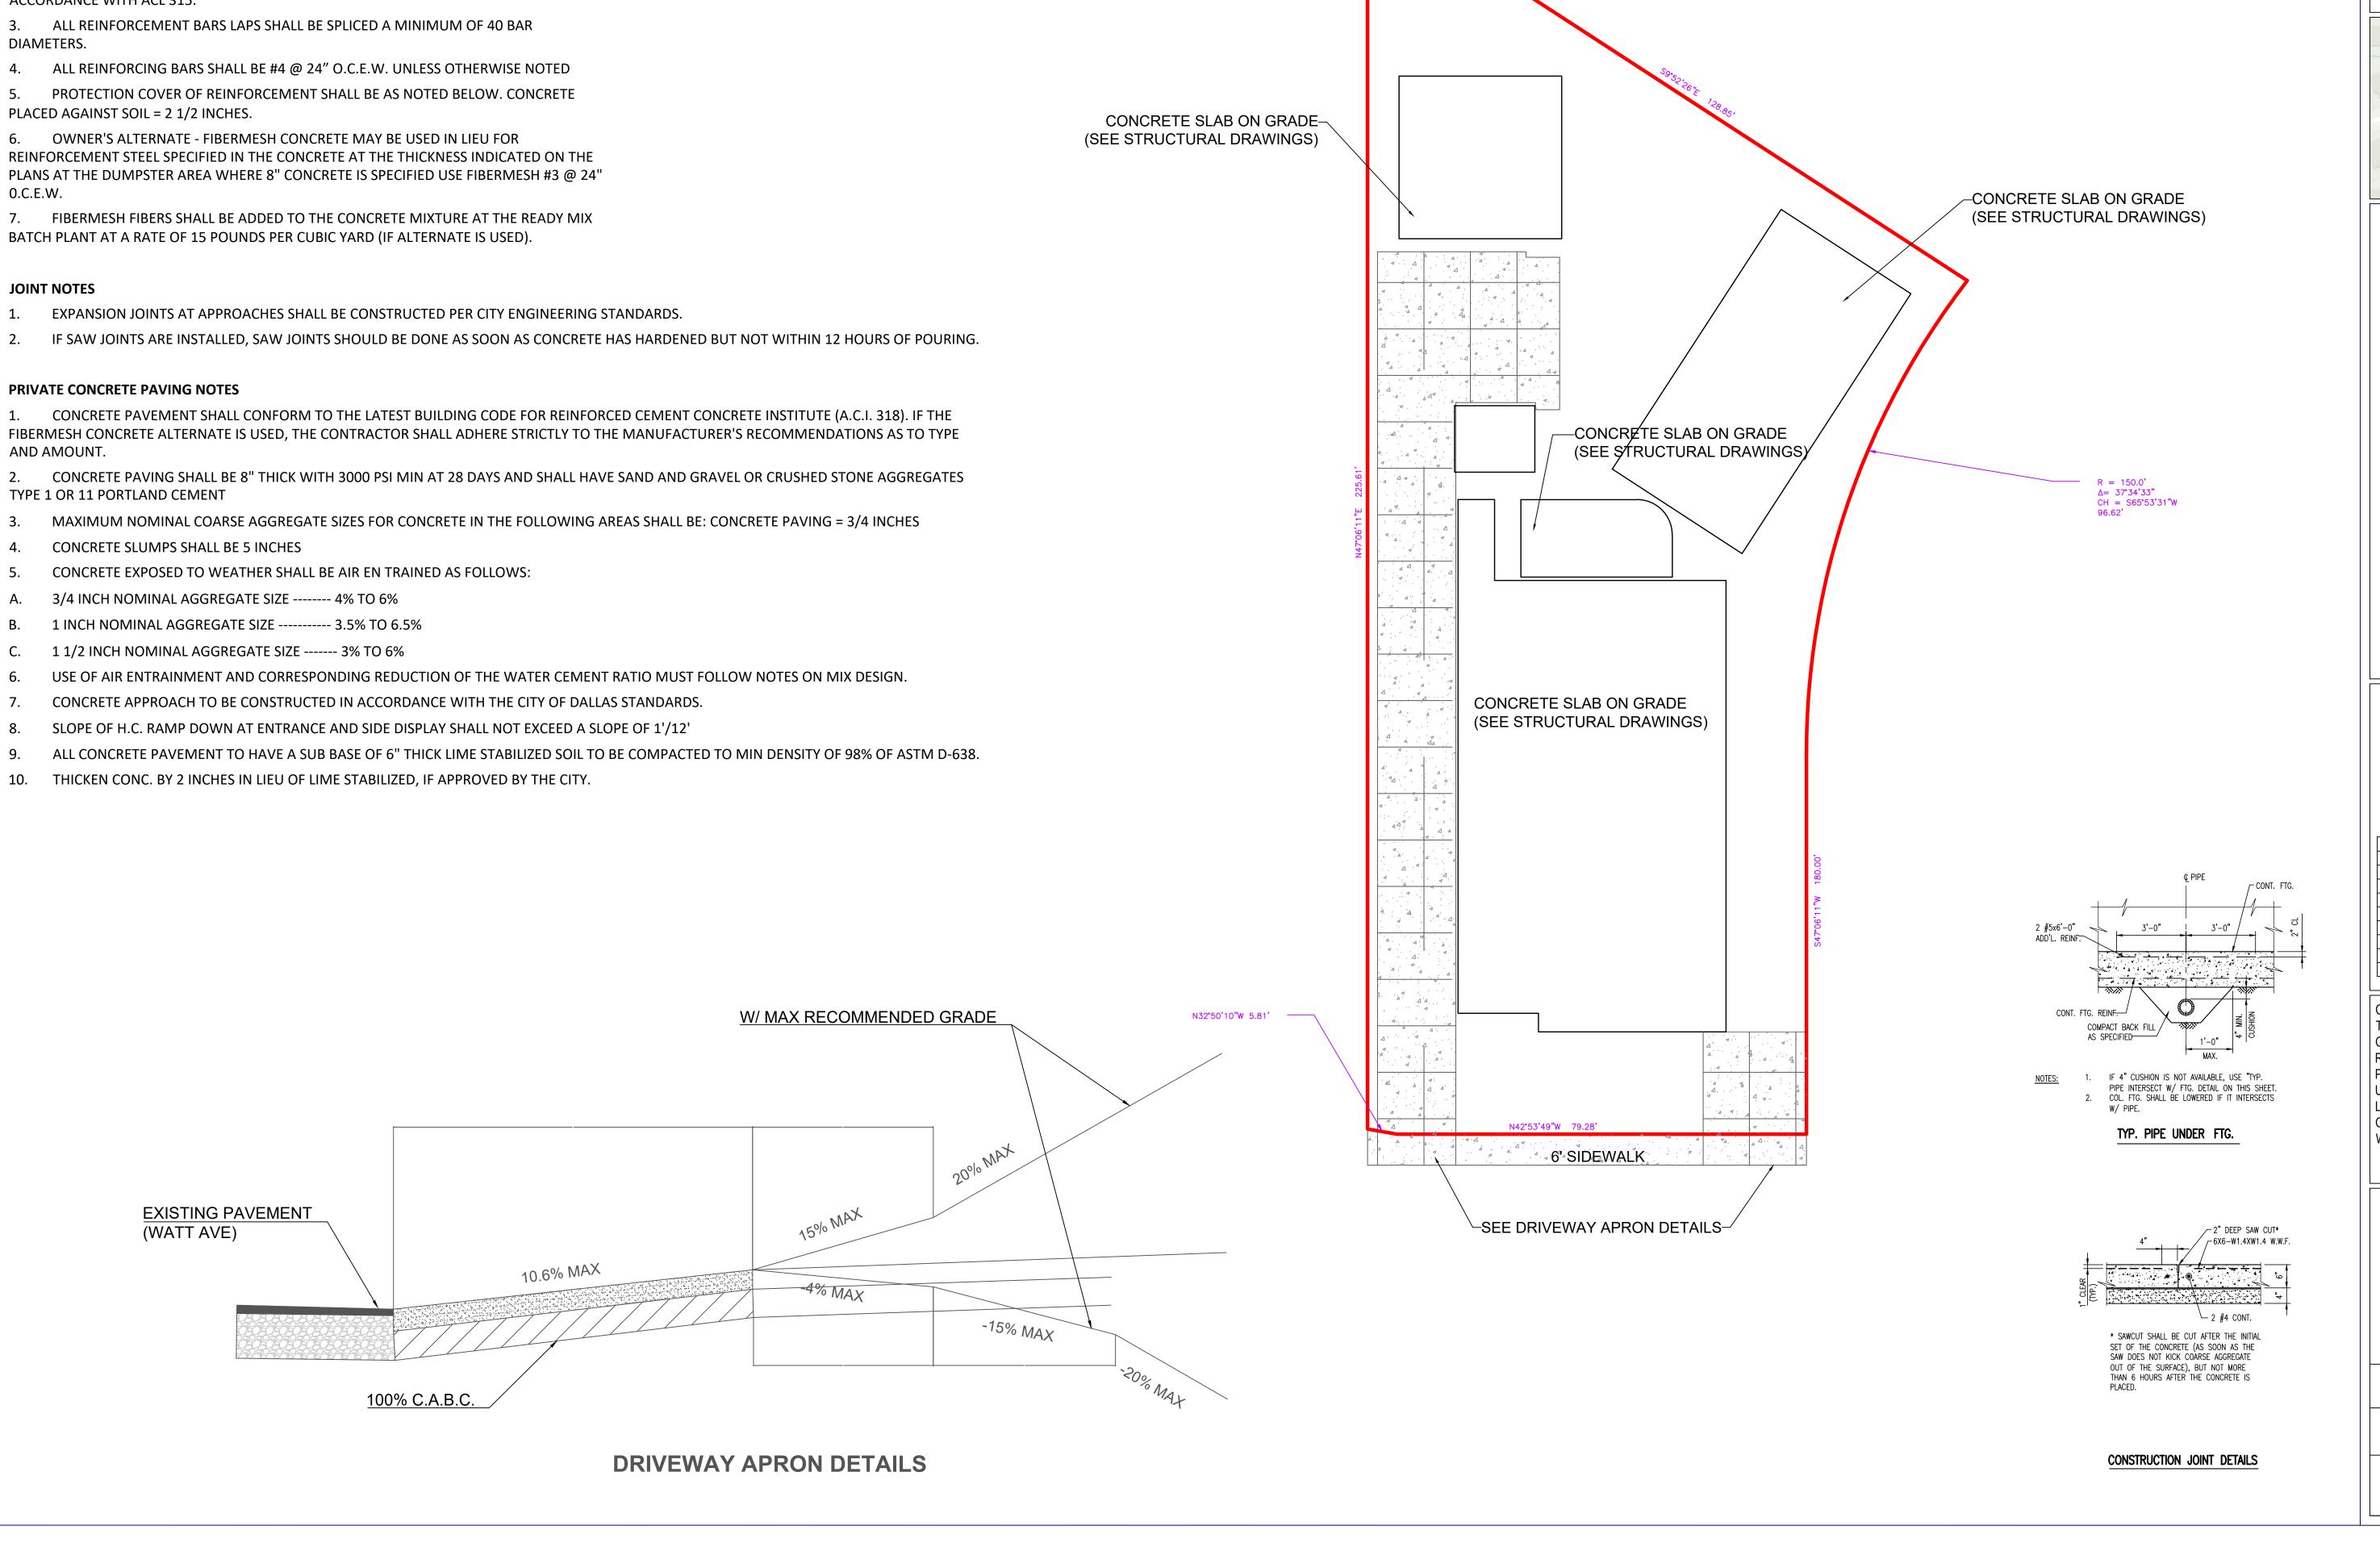

S93°01'53"W 12.12'


LEGEND

PROPERT LINE

CONST. JOINT @ 12' O.C.

CONCRETE PAVEMENT

4 4 4 4

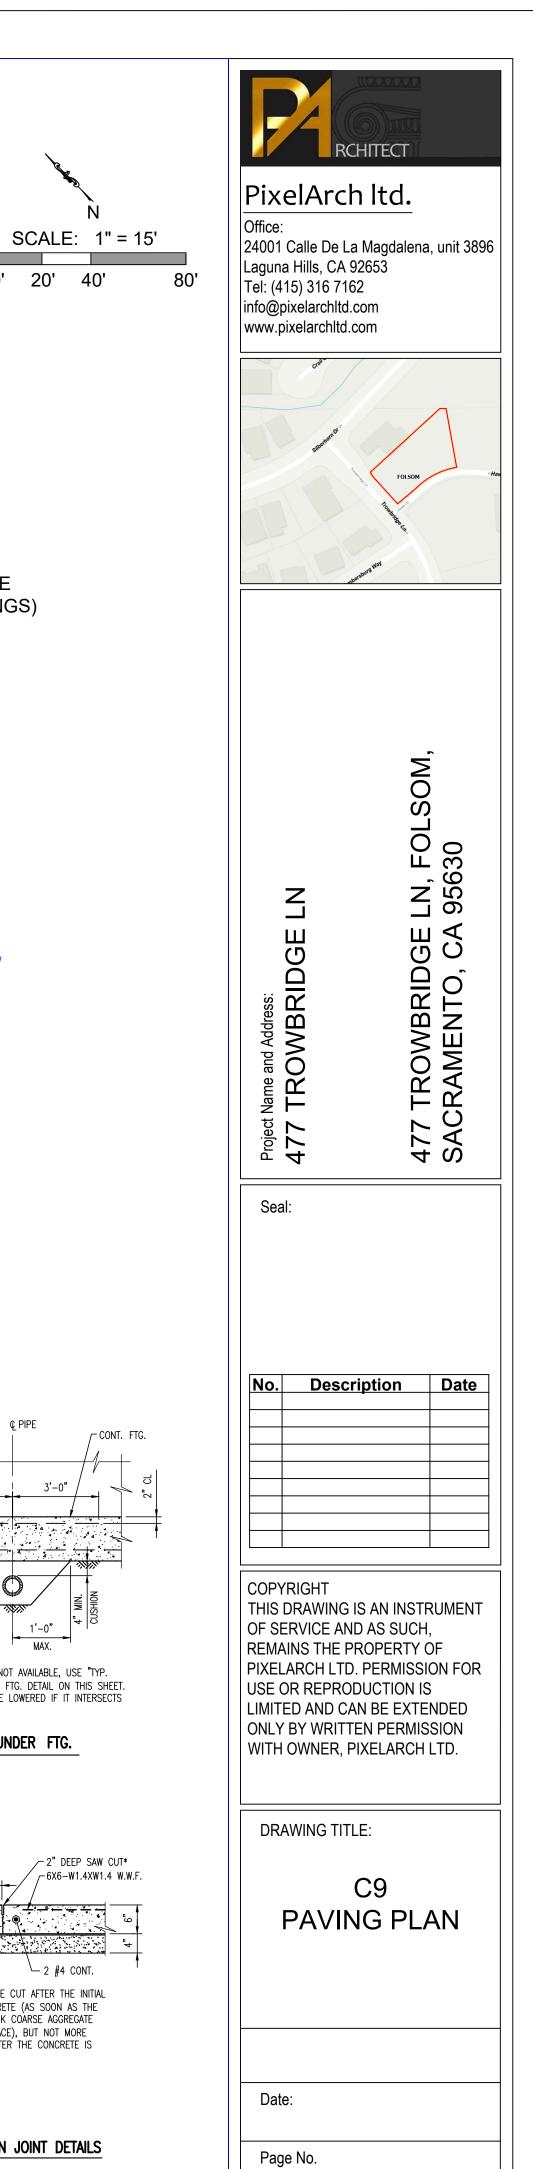

0' 20' 40'

NOTES:

- 1. WATER & WASTEWATER CROSSINGS SHALL CONFORM TO TCEQ DESIGN CRITERIA.
- TCEQ DESIGN CRITERIA.


 2. ALL UTILITY MATERIAL & WORK SHALL CONFORM TO THE LATEST UNIFORM PLUMBING CODE AND CITY REQUIREMENTS.
- 3. CONTRACTOR TO FIELD VERIFY ALL EXISTING UTILITY SIZES, MATERIALS & LOCATIONS.
- 4. ALL SERVICE LINES TO BE CONSTRUCTED TO WITHIN 1' OF LOT LINES.
- 5. SEE WASTEWATER STANDARD DETAILS.
- 6. WASTEWATER LINES TO BE PVC SDR-26.
- 7. MANHOLES WITH FOUR OR MORE PROPOSED LATERAL SERVICE LINE CONNECTIONS MUST HAVE THE HOLES FOR THE SERVICE LINES CONSTRUCTED BY THE MANHOLE MANUFACTURER.
- 8. WHERE WW SERVICES CONFLICT WITH DRIVEWAYS, WW SERVICES MAY BE ADJUSTED TO AVOID DRIVEWAY.
- 9. THE ENCASEMENT PIPE MUST MEET TCEQ REQUIREMENTS AND AT A MINIMUM BE CONSTRUCTED OF 150 PSI PRESSURE CLASS PIPE, SEALED AT BOTH ENDS WITH CEMENT GROUT OR A MANUFACTURED SEAL, BE TWO NOMINAL SIZES LARGER THAN THE WASTEWATER COLLECTION PIPE AND BE SUPPORTED BY SPACERS BETWEEN THE COLLECTION SYSTEM PIPE AND THE ENCASING PIPE AT A MINIMUM OF 5' INTERVALS.
- 10. 150 PSI PRESSURE CLASS PIPE FOR WASTEWATER MUST BE CONSTRUCTED PER TCEQ STANDARDS FOR WASTEWATER COLLECTION.
- 11. VERTICAL STACK FLOWLINES ARE CALLED OUT AT THE BEND OF THE TOP OF THE VERTICAL STACK.
- 12. ALL WASTEWATER MANHOLES TO BE WATER TIGHT UNLESS OTHERWISE NOTED.
- 13. ALL LATERALS TO BE CONSTRUCTED @ MIN. 2% SLOPE, UNLESS OTHERWISE NOTED.


Domestic Demand(Continous)						
"Fixture Type	"Fixture value		"Number of		"Total Fixture	
(Standardized at 60 psi)"	@ 60 psi"		Fixtures"		Value"	
Bathtub	8	x	6	=	48	
Bedpan Washers	10] x [3	=	30	
Bidet	2]x[4]=	8	
Faucet (kitchen sink)	2.2]x[8]=	17.6	
Faucet (lavatory)	1.5]x[14]=	21.0	
Shower Head (shower only)	2.5	x	4	=	10.0	
Faucet (utility sink)	4	x	4	=	16	
Urinal (flush valve)	35]x[3]=	105	
Toilet Flush Valve	35] x [8]=	280	
Dishwasher	2	x	2]=	4	
Clothes Washer	6	x	3]=	18	
1	557.6					

CALCULATIONS:

FOLLOWING THE GUIDELINES OUTLINED IN AWWA M22, THE RECOMMENDED FIXTURE VALUE TABLE IS UTILIZED TO DETERMINE THE TOTAL FIXTURE VALUE. THIS DETERMINATION IS BASED ON ASSUMING A PRESSURE OF 60 PSI, RESULTING IN A CALCULATED FIXTURE VALUE OF 600. BY REFERENCING THE FIXTURE VALUE AND EMPLOYING THE WATER FLOW DEMAND PER FIXTURE VALUE GRAPH, THE WATER FLOW DEMAND FOR THE BUILDING CAN BE ESTABLISHED. THE CALCULATED WATER FLOW DEMAND AMOUNTS TO 49 GALLONS PER MINUTE (GPM).

S93°01'53"W 12.12'

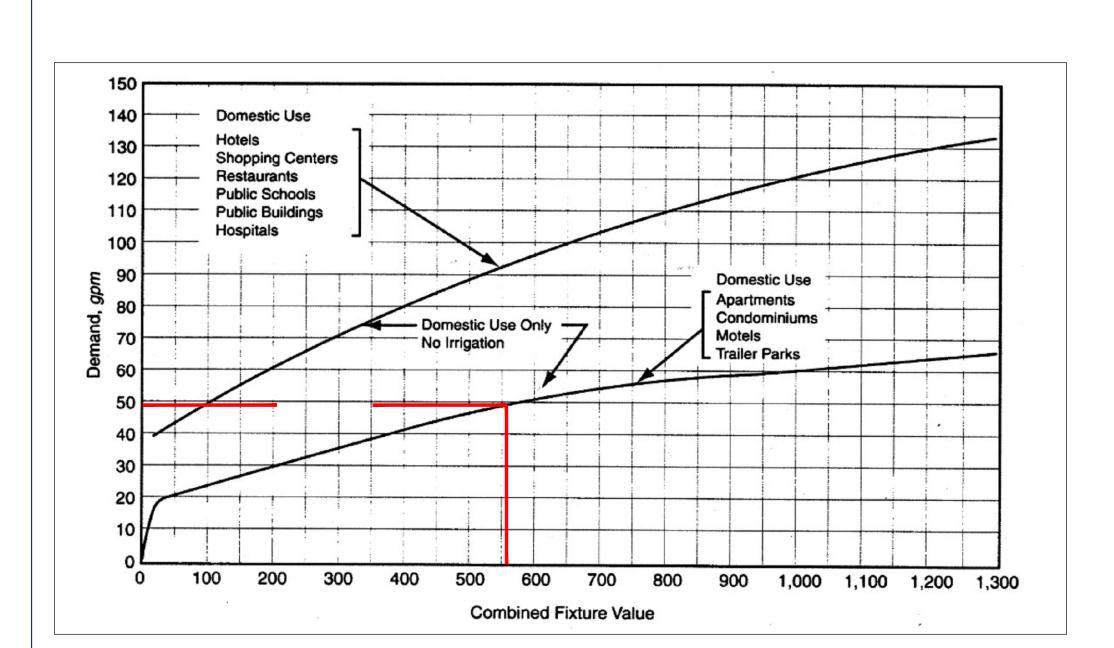

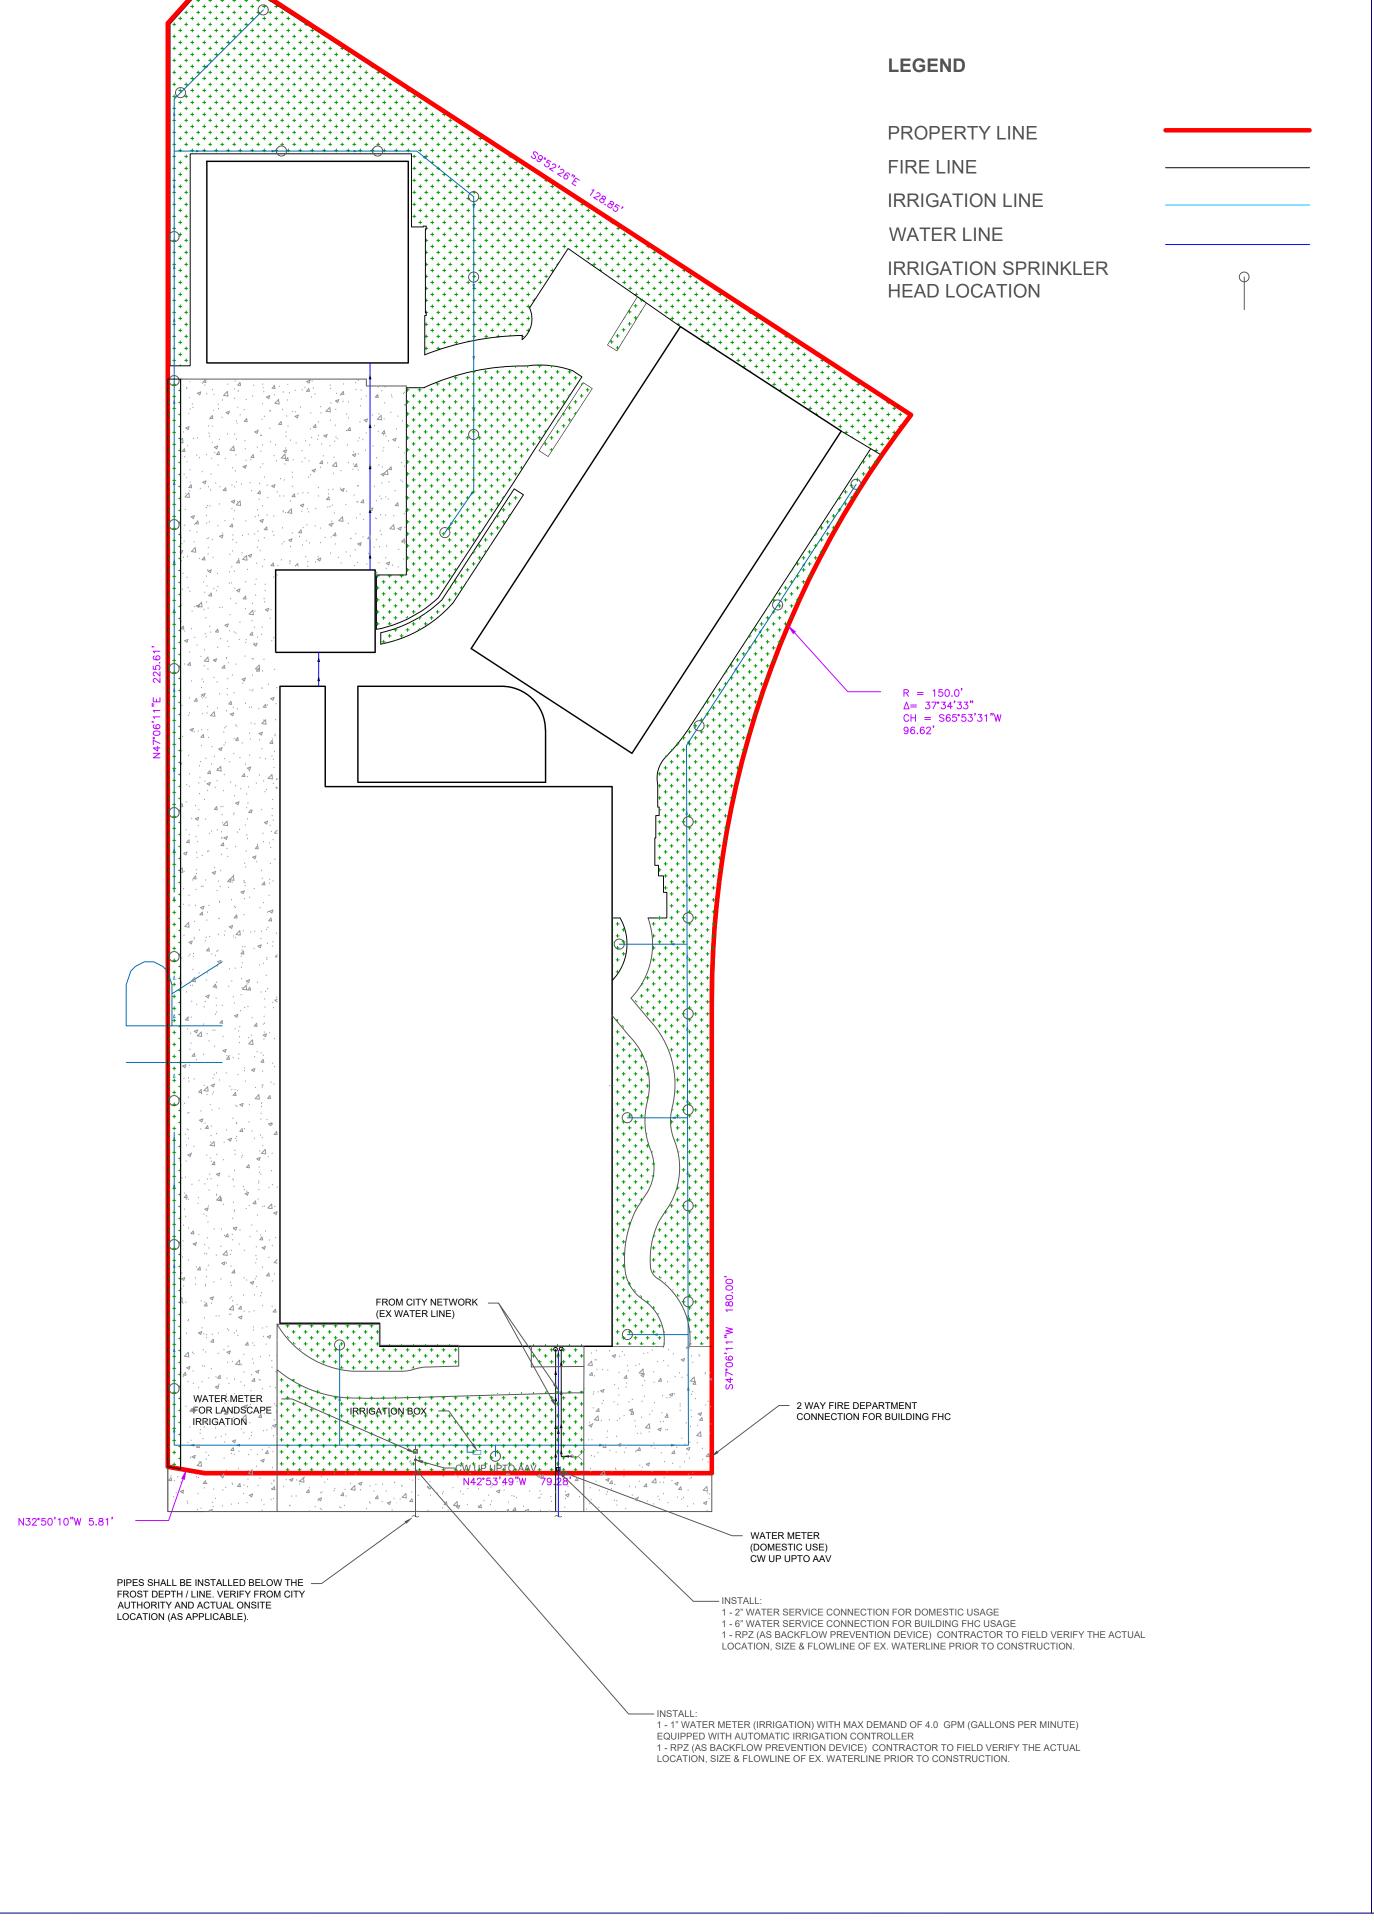



PixelArch ltd.

SCALE: 1" = 15'

0' 15' 30'

24001 Calle De La Magdalena, unit 3896 Laguna Hills, CA 92653 Tel: (415) 316 7162 info@pixelarchltd.com www.pixelarchltd.com



477 TROWBRIDGE LN, FOLSOM, SACRAMENTO, CA 95630

t Name and Address:
TROWBRIDGE I


No. Description Date


COPYRIGHT
THIS DRAWING IS AN INSTRUMENT
OF SERVICE AND AS SUCH,
REMAINS THE PROPERTY OF
PIXELARCH LTD. PERMISSION FOR
USE OR REPRODUCTION IS
LIMITED AND CAN BE EXTENDED
ONLY BY WRITTEN PERMISSION
WITH OWNER, PIXELARCH LTD.


DRAWING TITLE:

C10 WATER LINE PLAN

Date:

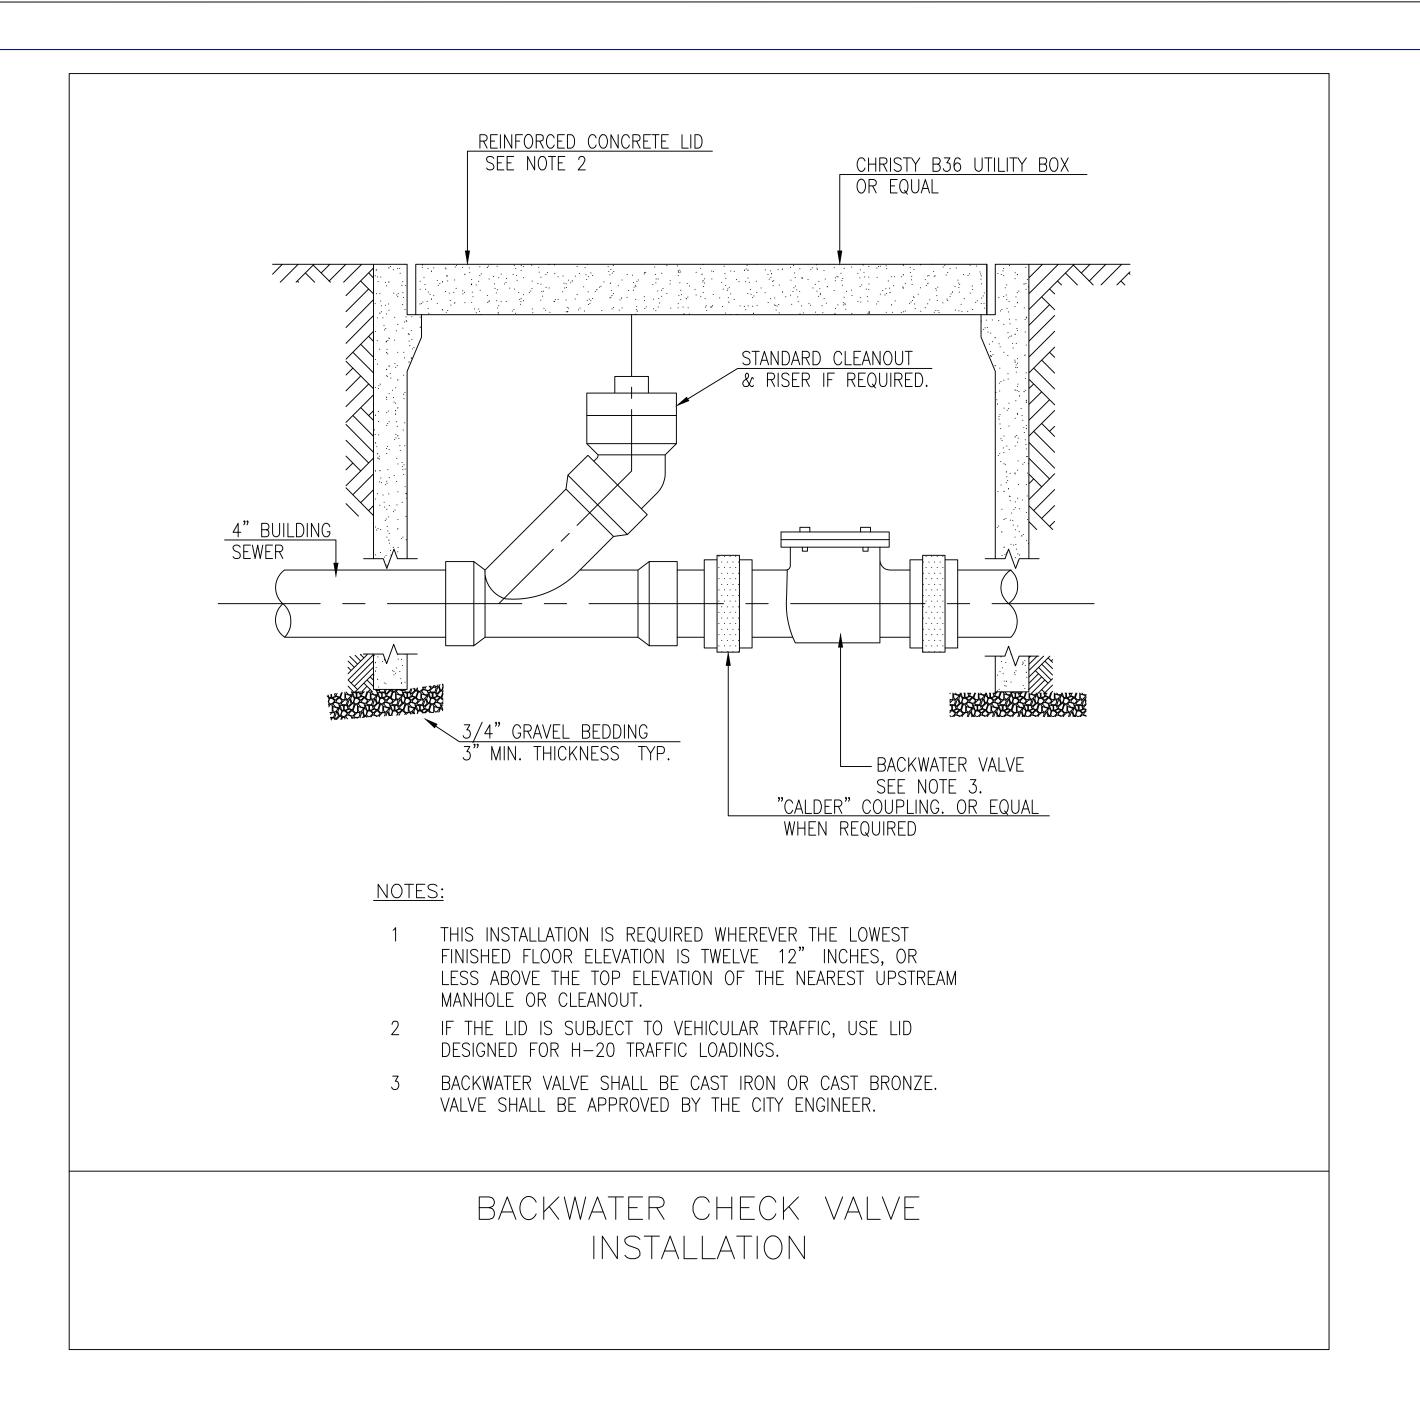

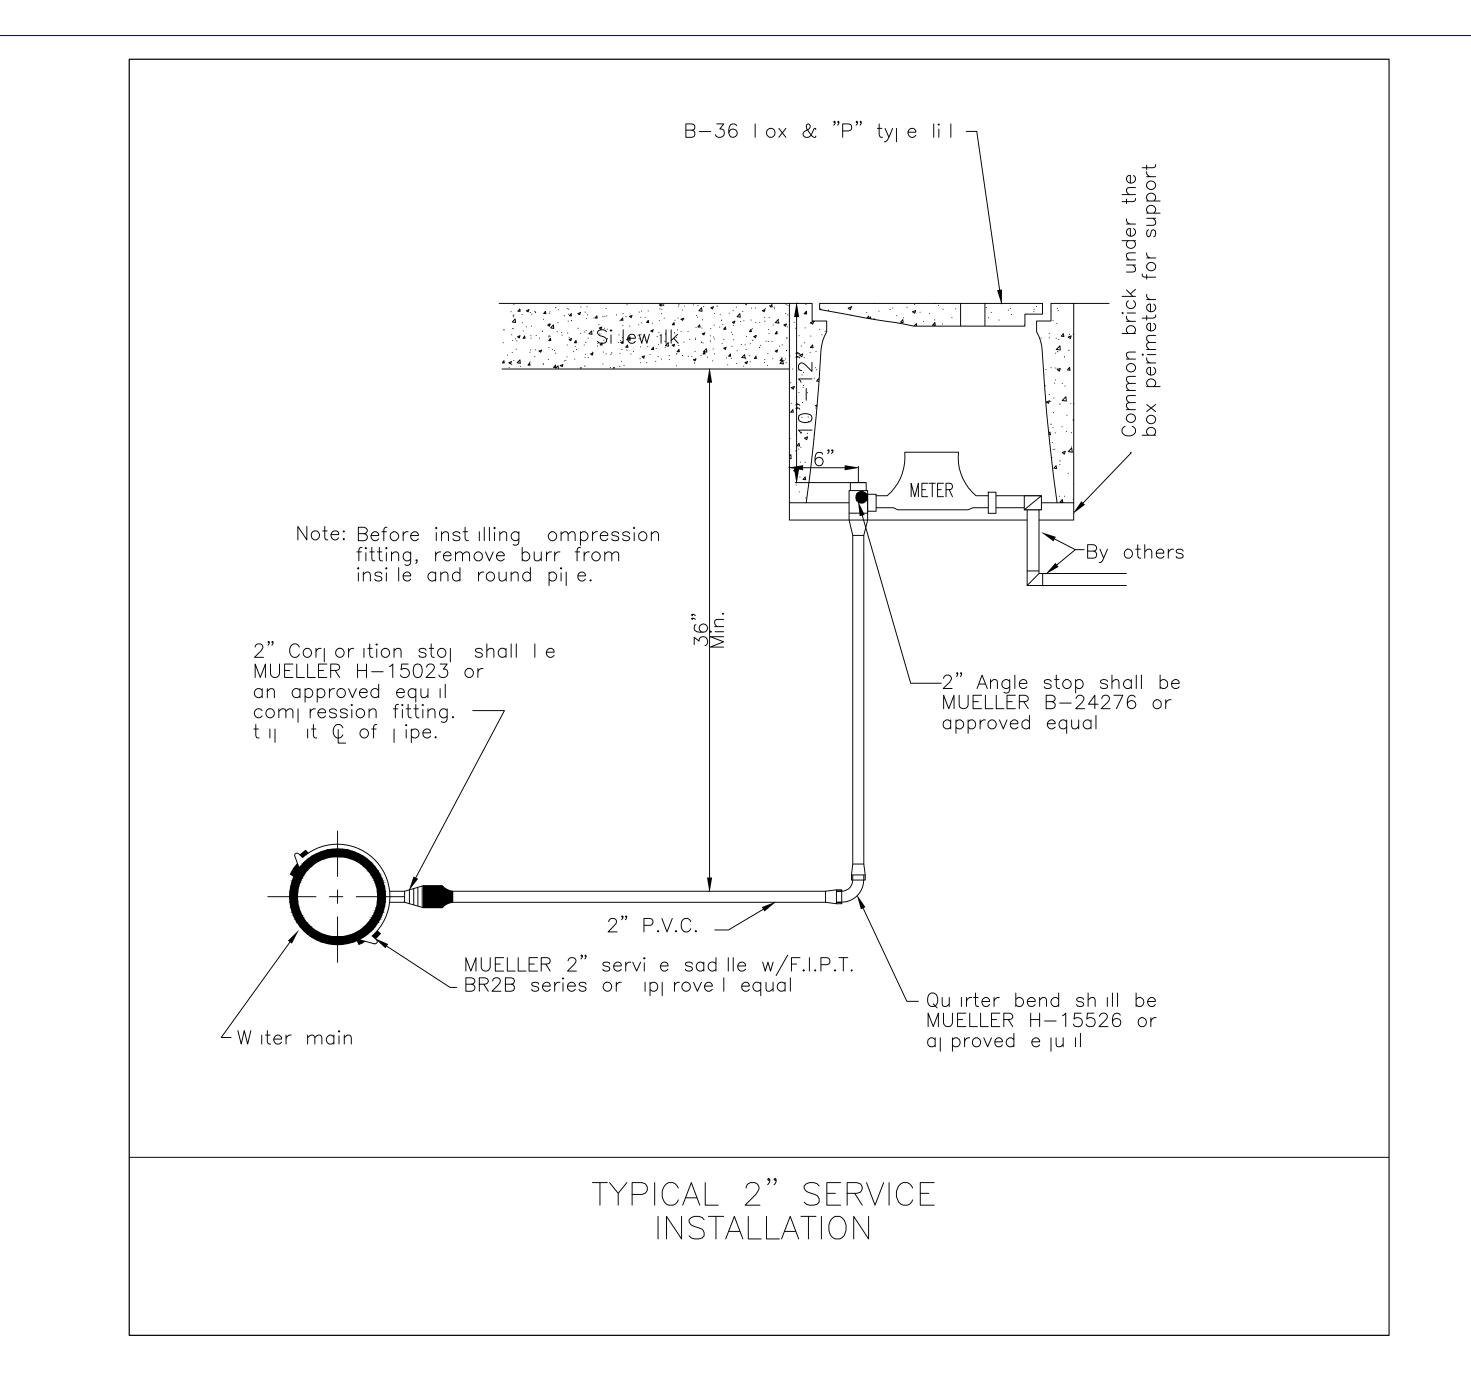

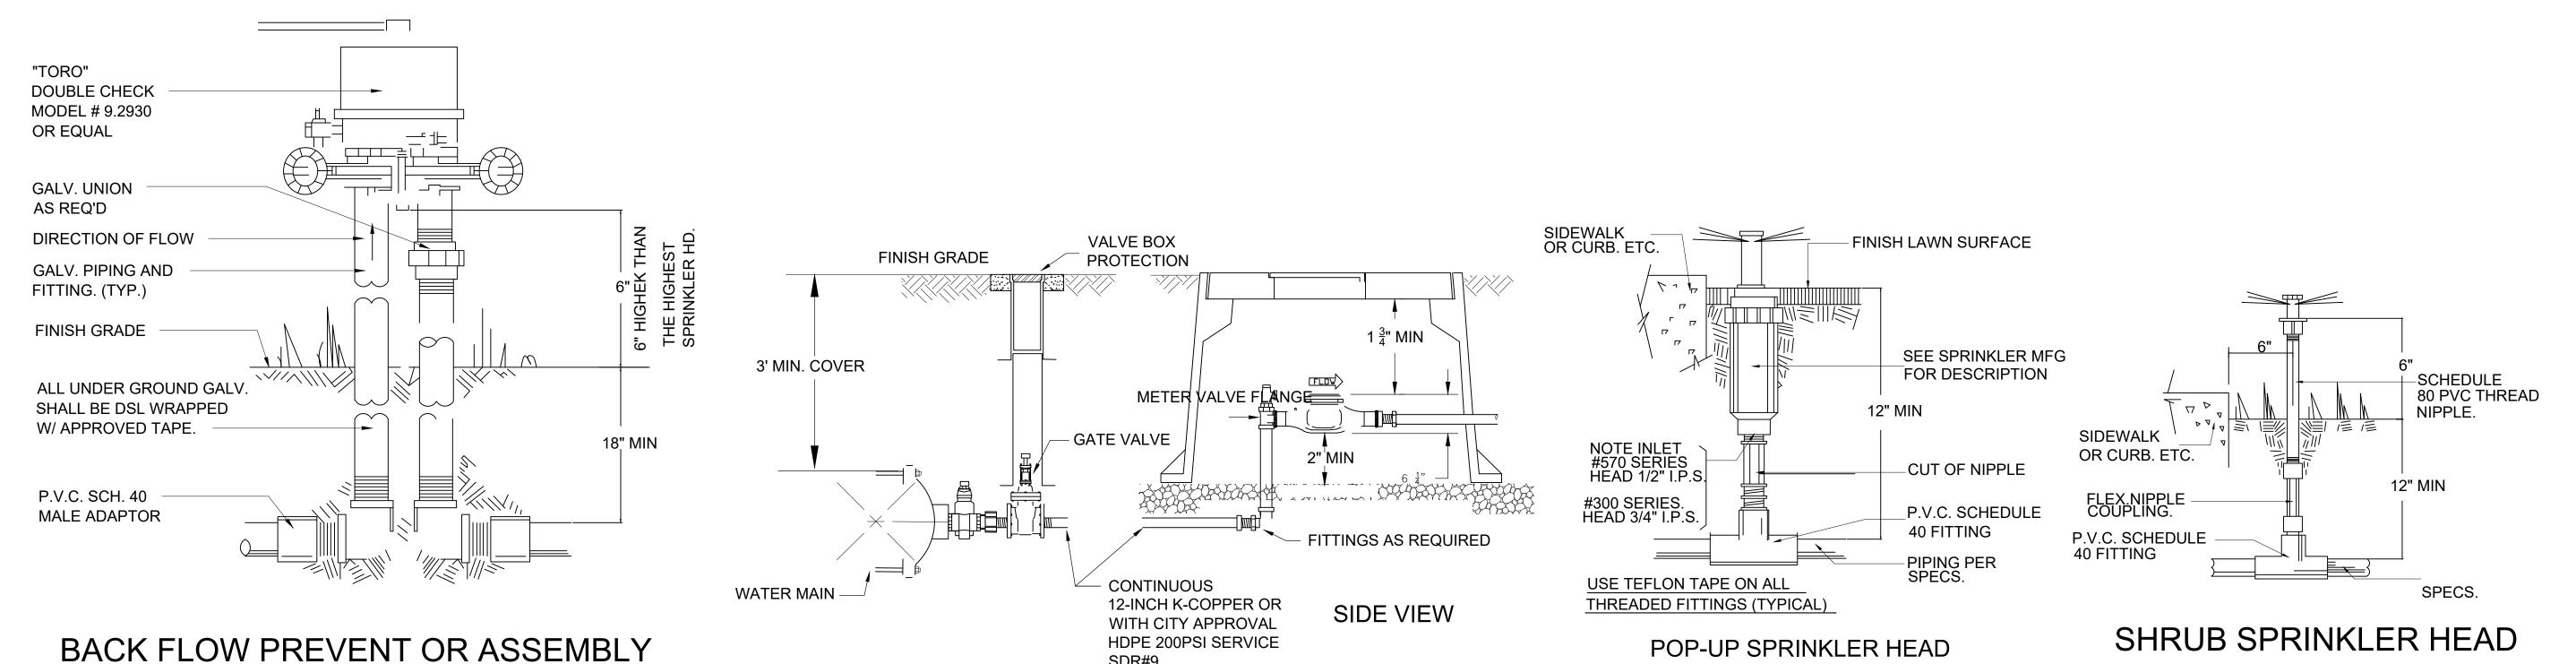

WITH TRACING WIRE



PixelArch Itd.

Office:

24001 Calle De La Magdalena, unit 3896 Laguna Hills, CA 92653 Tel: (415) 316 7162 info@pixelarchltd.com www.pixelarchltd.com



477 TROWBRIDGE LN 477 TROWBRIDGE LN, FOLSOM, SACRAMENTO, CA 95630


No. Description Date

COPYRIGHT
THIS DRAWING IS AN INSTRUMENT
OF SERVICE AND AS SUCH,
REMAINS THE PROPERTY OF
PIXELARCH LTD. PERMISSION FOR
USE OR REPRODUCTION IS
LIMITED AND CAN BE EXTENDED
ONLY BY WRITTEN PERMISSION
WITH OWNER, PIXELARCH LTD.

DRAWING TITLE:

C11 WATER & IRRIGATION STANDARD DETAILS


Date:

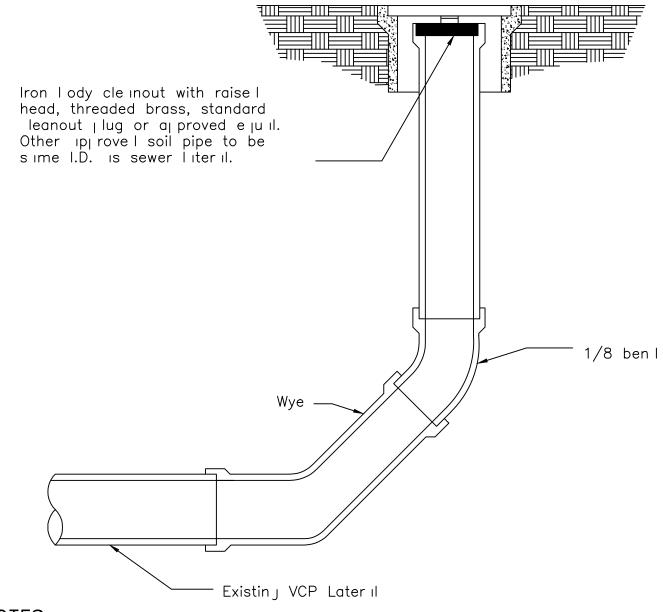

NOTES:

- 1. Box shill le Christy #VI sewer cleinout box. Lid shall be Christy P213 for 4" risers; 4F36 lox and C230 lid for 6" risers; G12 lox for 8" riser; or aj proved e ju ils.
- 2. Ba kfill for cle inout shall I e ompa te I by accept ible metho ls. Jetting is not is not | ermitte I.
- 3. Cle inout maintenance and repla ement of defective or broken pirts shall be it the property owner's expense.
- 4. Loc ite Cle inout conveniently within City Right of Wiy.

SANITARY SEWER CLEANOUT

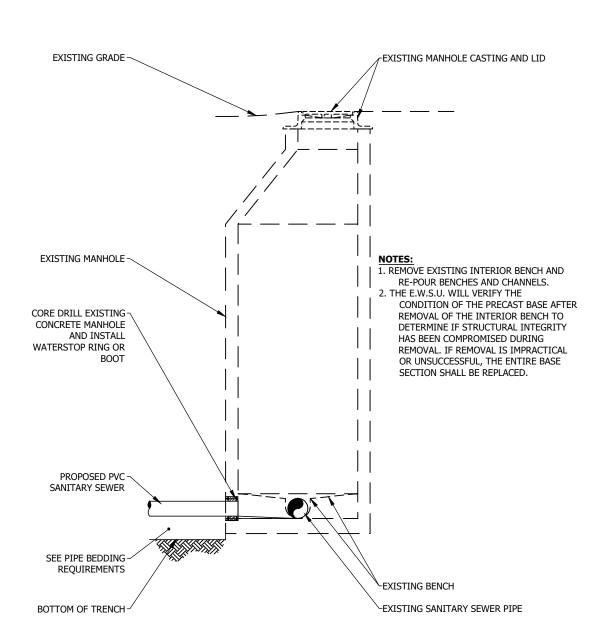

NEW PIPE CONNECTION TO EXISTING MANHOLE



LN, FOLSOM, 95630

477 TROWBRIDGE SACRAMENTO, CA

No. Description Date

THIS DRAWING IS AN INSTRUMENT

PIXELARCH LTD. PERMISSION FOR

LIMITED AND CAN BE EXTENDED

ONLY BY WRITTEN PERMISSION WITH OWNER, PIXELARCH LTD.

WASTE WATER

LINE

OF SERVICE AND AS SUCH,


USE OR REPRODUCTION IS


DRAWING TITLE:


Page No.

COPYRIGHT

t Name and Address:

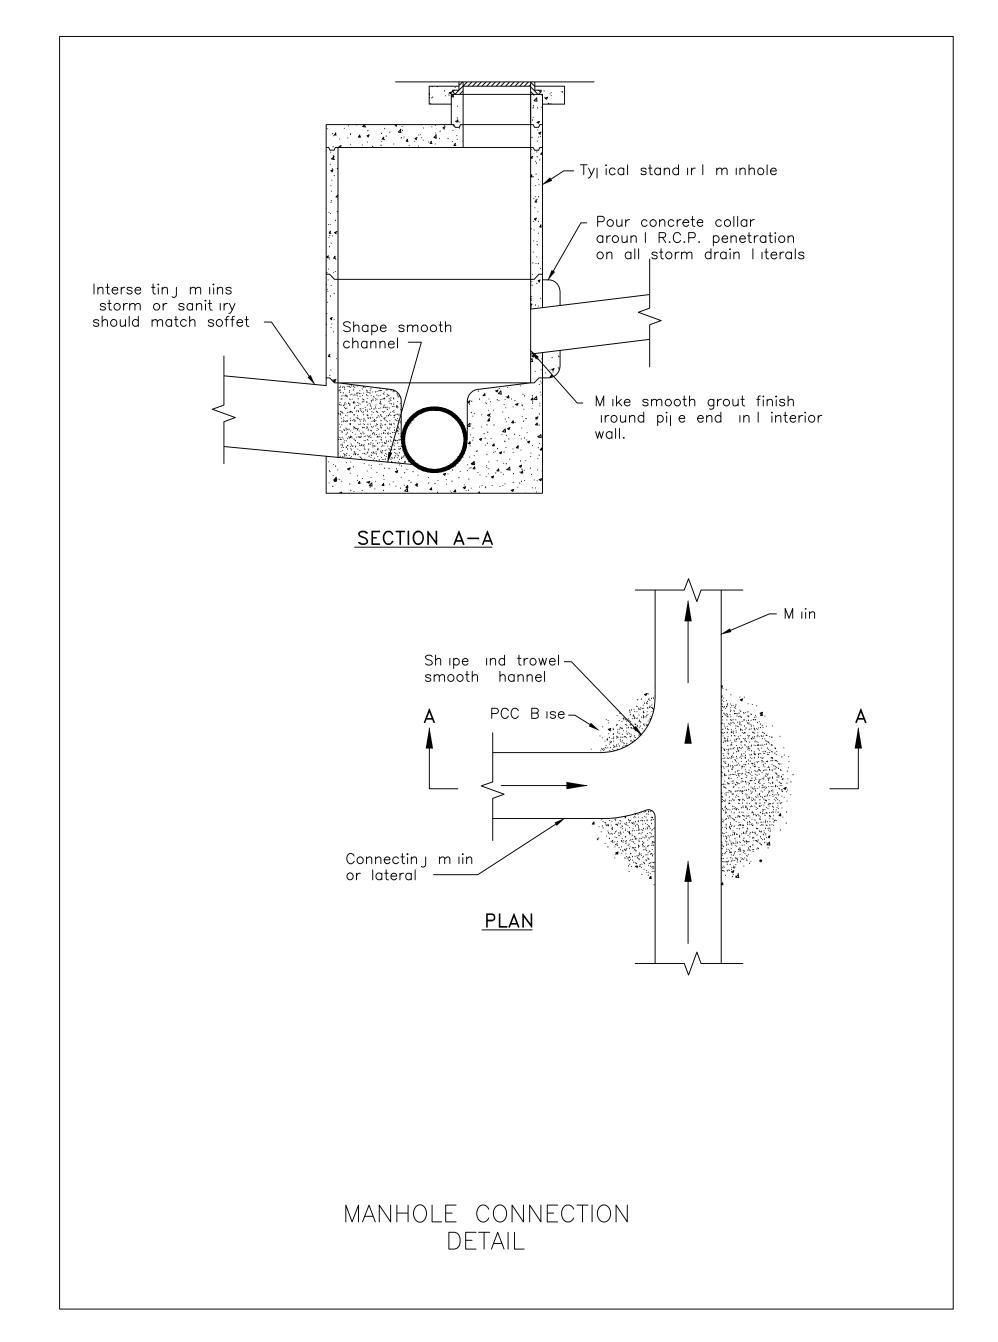

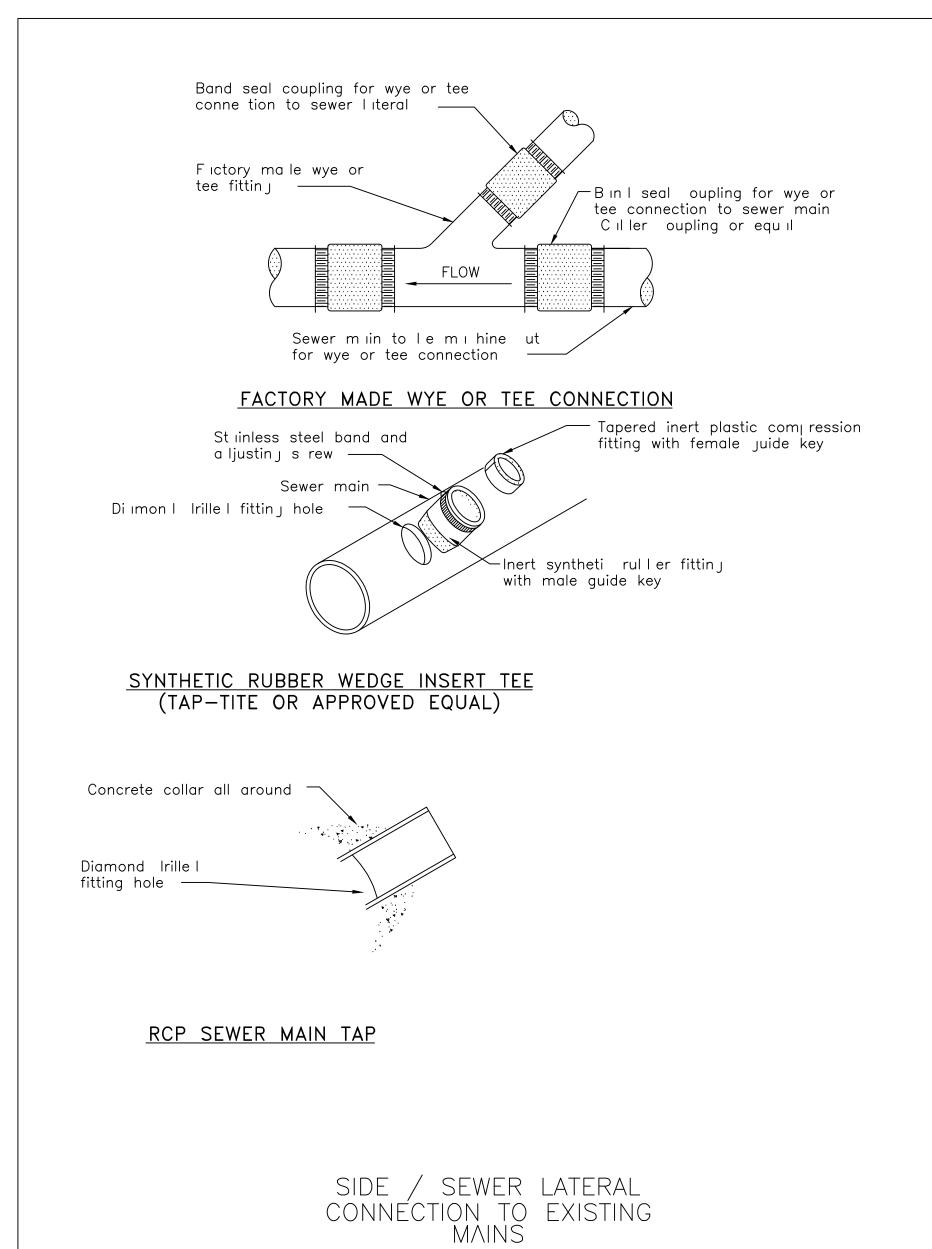

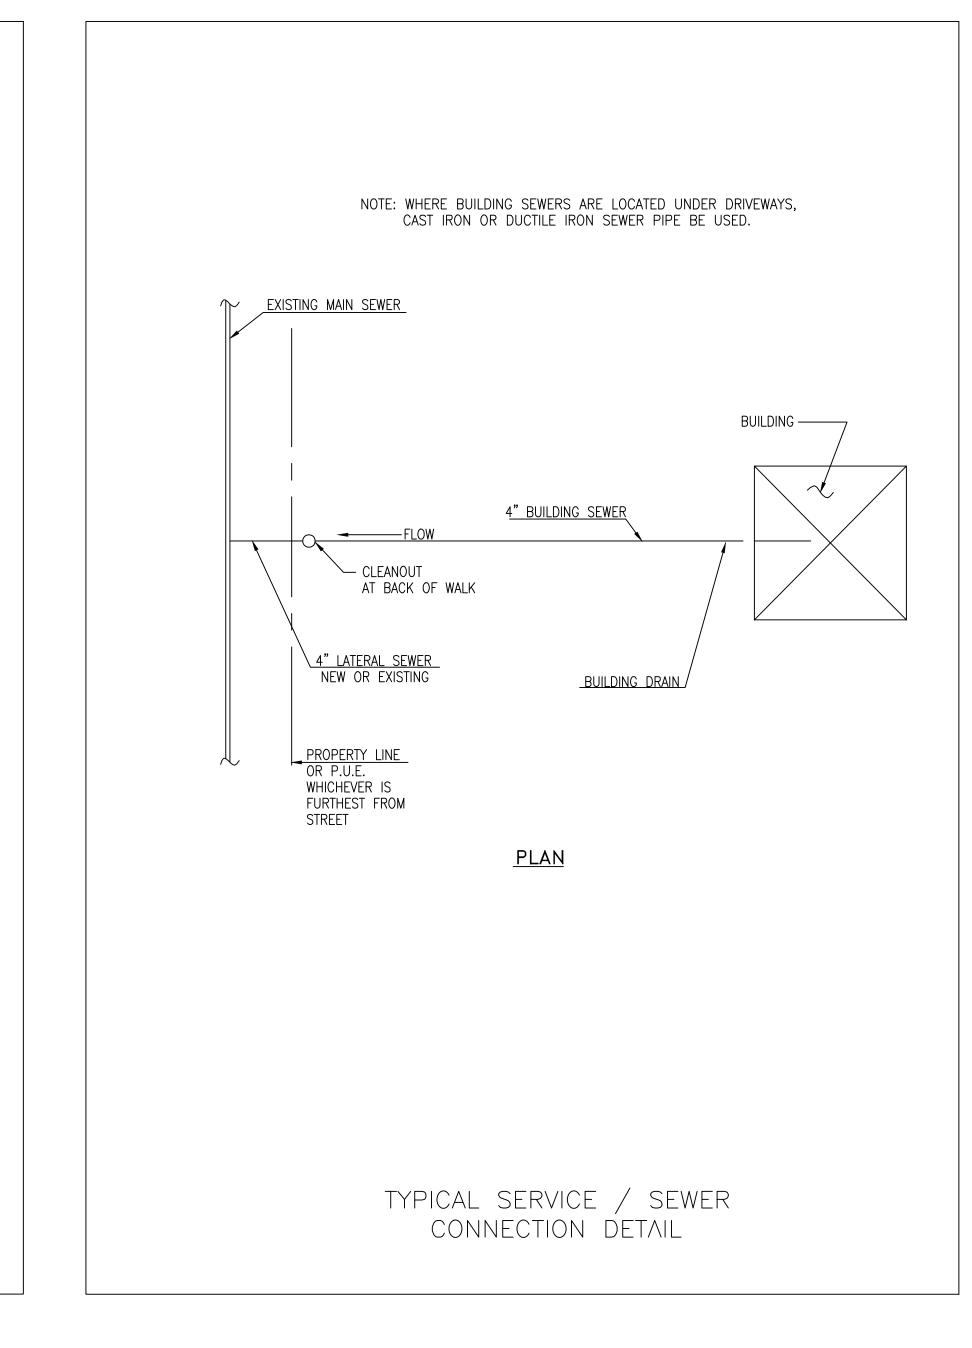



PixelArch ltd.

24001 Calle De La Magdalena, unit 3896 Laguna Hills, CA 92653 Tel: (415) 316 7162 info@pixelarchltd.com www.pixelarchltd.com



Project Name and Address:
477 TROWBRIDGE LN
477 TROWBRIDGE LN, FOLSOM,
SACRAMENTO, CA 95630

COPYRIGHT
THIS DRAWING IS AN INSTRUMENT
OF SERVICE AND AS SUCH,
REMAINS THE PROPERTY OF
PIXELARCH LTD. PERMISSION FOR
USE OR REPRODUCTION IS
LIMITED AND CAN BE EXTENDED
ONLY BY WRITTEN PERMISSION
WITH OWNER, PIXELARCH LTD.

DRAWING TITLE:

C13 WASTE WATER STANDARD DETAILS

Date:

SITE ANALYSIS

 BUILDINGS:
 6,395 SQ. FT.

 LANDSCAPE:
 5,099 SQ. FT.

 DRIVEWAY:
 3,232 SQ. FT.

 OPEN SPACE:
 2,322 SQ. FT.

 POOL:
 450 SQ.FT.

 BASKETBALL COURT:
 1,800 SQ.FT.

 TOTAL
 19,298 SQ. FT.

LEGEND

PROPERTY LINE

SEWER SERVICE

CLEAN OUT


LANDSCAPE

DRIVEWAY PAVEMENT

WATER METER

IRRIGATION SPRINKLER

STORM WATER CASH BASIN

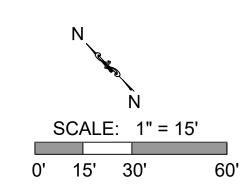


PLANTING TABLET (FERTI-TAB) SHALL BE PLACED BELOW FINISH GRADE NEAR ROOT FOUNDATION AT DEPTH & QUANTITY PER MANUFACTURER'S RECOMMENDATIONS.


ALL LANDSCAPE INSTALLATION SHALL BE IN ACCORDANCE WITH CITY STANDARDS, MANUFACTURER'S RECOMMENDATION, SECTION 20 OF THE STANDARD SPECIFICATIONS AND AS DIRECTED BY THE CITY ENGINEER.

ALL MATERIALS USED SHALL BE NEW AND FREE FROM DEFECTS.

SEE APPROVED LANDSCAPE AND IRRIGATION PLANS FOR SPECIFIC MODEL NO., SIZE, QUANTITY, MANUFACTURERS AND PERFORMANCE OF THE VARIOUS ITEMS.

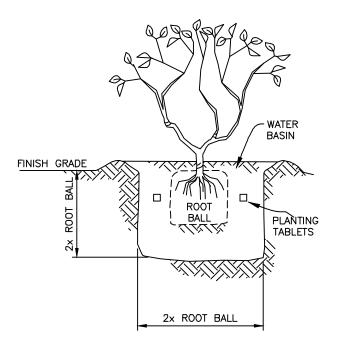

SHRUB PLANTING DETAIL

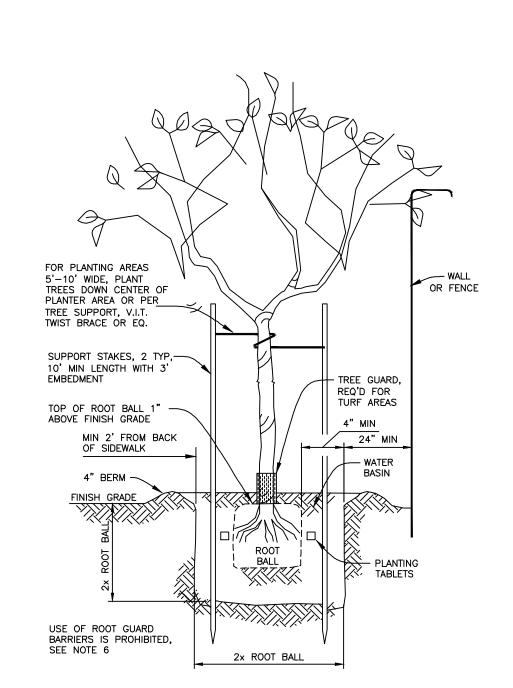


TREE PLANTING DETAIL





PixelArch ltd.

24001 Calle De La Magdalena, unit 3896 Laguna Hills, CA 92653 Tel: (415) 316 7162 info@pixelarchltd.com www.pixelarchltd.com

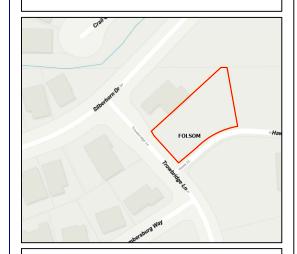

477 TROWBRIDGE LN, FOLSOM, SACRAMENTO, CA 95630

Seal:

t Name and Address:

0.	Description	Date
+		

COPYRIGHT
THIS DRAWING IS AN INSTRUMENT
OF SERVICE AND AS SUCH,
REMAINS THE PROPERTY OF
PIXELARCH LTD. PERMISSION FOR
USE OR REPRODUCTION IS
LIMITED AND CAN BE EXTENDED
ONLY BY WRITTEN PERMISSION
WITH OWNER, PIXELARCH LTD.

DRAWING TITLE:

C14 SITE PLAN

Date: